

ARCHITECTURE
INTERIOR DESIGN
LANDSCAPE ARCHITECTURE

ADDENDUM NO. 3

Project Name: Building Renovation for Haverford Township Free Library

Project No.: 7010.03-22

Date of Issue: October 10, 2023

Notice 1: Attach this addendum to the Project Manual for this project. It modifies and

becomes part of the Bidding Documents. Work or material not specifically mentioned herein is to be as described in the main body of the Project

Manual, and as shown on the drawings.

<u>Table of Contents</u>: This Addendum includes the following:

A. Written addendum (six pages total)

B. Revised drawing sheets **S1.0**, **S1.1**, **S1.2**, **S1.3**, revision dated 10/10/23, and **DMPE1.0**, **DMPE1.1**, **DMPE1.2**, **DMPE1.3**, **M1.2**, **M2.0**, **M2.2**, **M2.3**, **P1.0**, **P1.1**, **P1.3**, **P2.0**, **E1.3**, **E1.5** and **E1.6**, revision dated

10/4/23 (19 pages total)

CHANGES TO DRAWINGS

- 1. On Sheet **A0.0**, at Keynote W04.03, change "...with painted 6" CMU..." to "...6" CMU with epoxy paint both sides...".
- 2. On Sheet A3.1, at detail 2/A3.1 see clarification of the extent of WT-4. The revised sheet is attached as part of this addendum.
- 3. On Sheet **S1.0**, add extent of existing floor slab in basement to be removed as part of the lowering of the basement floor, add Note 13, and add elevation of footing at column F/11. The revised sheet is attached as part of this addendum.
- 4. On Sheet **S1.1**, add CMU infill in openings at Mechanical Room areaway and add Note 8. The revised sheet is attached as part of this addendum.
- 5. On Sheet **S1.2**, add Note 10. The revised sheet is attached as part of this addendum.
- 6. On Sheet **S1.3**, add Note 21. The revised sheet is attached as part of this addendum.
- 7. On Sheet **DMPE1.0**, revise Mechanical Demolition Notes, Plumbing Demolition Keynotes, Electrical Demolition Keynotes, and Electrical Demolition Notes as indicated. The revised sheet is attached as part of this addendum.
- 8. On Sheet **DMPE1.1**, revise Mechanical Demolition Notes and Plumbing Demolition Keynotes, as indicated. The revised sheet is attached as part of this addendum.
- 9. On Sheet **DMPE1.2**, revise Mechanical Demolition Notes and Plumbing Demolition Keynotes, as indicated. The revised sheet is attached as part of this addendum.
- 10. On Sheet **DMPE1.3**, revise Mechanical Demolition Notes, as indicated. The revised sheet is attached as part of this addendum.
- 11. On Sheet M1.2, revise references to Rad-2 in Meeting Room (Room 220). The revised sheet



Building Renovation for Haverford Township Free Library Addendum No. 3 Bernardon Project No. 7010.03-22

October 10, 2023

Page 2

- is attached as part of this addendum.
- 12. On Sheet **M2.0**, revise Air Handling Unit Schedule as indicated. The revised sheet is attached as part of this addendum.
- 13. On Sheet M2.2, revise Air Device Schedule as indicated. The revised sheet is attached as part of this addendum.
- 14. On Sheet **M2.3**, revise Hot & Chilled Water Piping Diagram and add Hot Water Sequence Notes as indicated. The revised sheet is attached as part of this addendum.
- 15. On Sheet **P1.0**, add note regarding perforated PVC pipe as indicated. The revised sheet is attached as part of this addendum.
- 16. On Sheet **P1.1**, revise note pointing to Fire line at Mechanical Room areaway as indicated. The revised sheet is attached as part of this addendum.
- 17. On Sheet **P1.3**, revise note pointing to Fire line at Mechanical Room areaway as indicated. The revised sheet is attached as part of this addendum.
- 18. On Sheet **P2.0**, at Fire Service Detail 9, delete backflow preventer as indicated. A back flow preventer is provided in the meter pit provided by the GC. The revised sheet is attached as part of this addendum.
- 19. On Sheet **E1.3**, revise Electrical Keynotes E1 and E5, as indicated. The revised sheet is attached as part of this addendum.
- 20. On Sheet **E1.3**, at conduit along column line 7 between column lines C and D, move the two conduits referenced by Keynote E2 exposed to Storage (Room 007A).
- 21. On Sheet **E1.4**, at conduit enclosure along column line 7 between column lines C and D, delete the conduit enclosure. Move the two conduits referenced by Keynote E3 exposed to Storage (Room 105B).
- 22. On Sheet **E1.5**, revise note regarding Innovation Zone exhaust system, as indicated. The revised sheet is attached as part of this addendum.
- 23. On Sheet E1.5, at conduit enclosure along column line 7 between column lines C and D, delete the conduit enclosure. Move the two conduits referenced by Keynote E3 exposed to Storage (Room 204A).
- 24. On Sheet **E1.6**, add note regarding Innovation Zone exhaust system, as indicated. The revised sheet is attached as part of this addendum.

CHANGES TO SPECIFICATIONS

1. Section 093000 *Tiling:* At subparagraph 3.7.A.1, replace "...TCNA F101..." with "...TCNA F102..."

RESPONSES (R) TO BIDDER QUESTIONS (Q):

- Q1: Based on the time frame between the site visit and bid due date we respectfully request a two-week extension.
- R1: See Addendum 2, dated October 9, 2023



Building Renovation for Haverford Township Free Library Addendum No. 3
Bernardon Project No. 7010.03-22

October 10, 2023

- Page 3
- Q2: Will the Owner provide testing of Fluid-Applied Membrane Air Barriers as part of Section 2.2.7 of A201?
- R2: Yes, Owner will provide testing of Fluid Applied Membrane Air Barriers.
- Q3: Is the Water Based Intumescent coatings required at all locations tagged G07.01? It appears that all of these locations have a separation from ambient spaces with either acoustic, gwb, or metal panel and the intumescent coating may not be necessary.
- R3: Yes, the Water Based Intumescent coating is required at all locations tagged G07.01.
- Q4: Please confirm the GC is not responsible to saw cut for raceways, plumbing lines, floor boxes, etc and is to be completed by their respective trades.
- R4: Correct, each Prime Contractor is to sawcut for their own work; including patching those cuts.
- Q5: Please advise on locations of FM-2, unable to locate on the drawings.
- R5: FM-2 is a Glass Film identified on the Finishes Schedule on sheet I0.0. Location for FM-2 is as noted on I1.2 Second Floor Finish Plan at Sensory Room (Room 201A).
- Q6: The specified grout for all wall tiles on this project is cement grout based on specifications on I-0.0. However, the tiling specs section 093000-9 specify we should use epoxy grout for all wall tiles. Can you please confirm whether the grout for all wall tile should be epoxy or cement based?
- R6: Grout type for wall tiles shall be cement-based as noted on I0.0. Epoxy grout is not required for this project. Revisions to Specification Section 093000 *Tiling*, will be issued in next addendum that includes cement-based grout.
- Q7: The specified floor method for the exterior tile (PV-1) is TCNA F101. This method calls for a 3/4" minimum to 2" maximum bonded mortar bed. Additionally, the specified material PV-1 is 2 CM thick. We didn't see any notes about a depressed slab in the structural drawings. Can you please confirm whether a mortar bed (wet bed) will be required for the PV-1 installation and please specify the mortar bed thickness required?
- R7: TCNA number for PV-1 to be F102, thinset mortar on waterproof membrane on new lightweight concrete topping. The PV-1 installation is to utilize the corrugated polyethylene waterproofing specified in 093000, paragraph 2.4.C, which is an uncoupling/waterproof membrane. See revision to Specification Section 093000 *Tiling*, subparagraph 3.7.A.1.



Building Renovation for Haverford Township Free Library Addendum No. 3
Bernardon Project No. 7010.03-22

October 10, 2023

Page 4

- Q8: Could you please confirm floor finish PV-1 is only required at the small exterior space outside Vestibule 100? Please confirm the exterior floor finish is not required going down the ramp shown next to it.
- R8: Extent of Paver PV-1 finish as shown on 1/I1.1, First Floor Finish Plan. Adjacent ramp shall be new poured concrete as per 6/A5.0.
- Q9: Base finish TB-1 is specified as a 4" x 24" cut tile. Does this finish need to be capped with Schluter at walls without wall tile above it? If so, can you specify a Schluter product line and finish?
- R9: TB-1 occurs only at base of walls with WT-1. Wherever WT-1 is indicated in Finish Plans provide TB-1 at its base. All other walls within Restroom that don't have wall tile shall receive VB-1 as noted in Finish Plans.
- Q10: Wall finish WT-4 is specified at living room 115 on I1.1. However, elevations of this space on sheet 3.1 elevation 2 don't show the location of WT-4. Could you please clarify the location of WT-4?
- R10: This will be clarified in the next addendum.
- Q11: Existing Ceiling Tiles Responsibility Please clarify the need to remove, store and re-install the existing ceiling tiles? Spec Section 011200-A.2 Requires the M.C. to remove and store ceiling tiles for work access. Drawings A1.4, A1.5 & A1.6 show new ceiling systems.
- R11: Ceiling finishes throughout the building are new, as indicated. The statement in Section 011200, subparagraph 1.9.A.2, refers to any new ceiling tiles and grid that are installed but have to be temporarily removed/replaced by the Mechanical Contractor during the course of constriction.
- Q12: Existing Rooftop Dunnage Modifications Please clarify who is responsible for the existing rooftop dunnage modifications? The specs and plans are not clear. Mechanical and structural drawings both say to check each other without clear responsibility assignment.
- R12: General Contractor is to provide modifications to existing dunnage and new steel as indicated. Mechanical Contractor is to provide curbs. Structural drawing notes refer to the MEP drawings only to coordinate the exact locations of the curb supports with the unit curbs.
- Q13: HVAC Rooftop Structural Steel Supports Please clarify who is to provide the structural steel supports for the HVAC rooftop equipment?
- R13: General Contractor is to provide structural steel supports. Mechanical Contractor is to provide curbs. Structural drawing notes refer to the MEP drawings only to coordinate the exact locations of the curb supports with the unit curbs.



Building Renovation for Haverford Township Free Library Addendum No. 3 Bernardon Project No. 7010.03-22

October 10, 2023 Page 5

- Q14: Refrigerant Piping Layouts The plans do not show the piping layouts between the AC & CU units? Will updated drawings be issued to show layouts?
- R14: The mechanical engineer does not typically show the routing of refrigerant piping. Updated drawings will not be provided.
- Q15: Radiators Schedule The radiators schedule identifies RAD-3 & RAD-6 as "Not Used". On M.12, two RAD-3s and one RAD-6 are shown. Will an updated schedule be provided?
- R15: Refer to drawing M1.5 for the correct numbering. See revision to Sheet M1.2 in this addendum.
- Q16: CV-8 & -10 Locations Unable to locate these control valves on the drawings. Please clarify locations?
- R16: CV-10 is to be furnished with CUH-2, CV-8 is to be furnished with AHU-1. They are to be integral to the equipment and therefore are not located on the plans.
- Q17: Existing Casework Demolition Please clarify who is responsible for removing the existing casework covering the radiators on site?
- R17: General Contractor is responsible for removing the existing casework covering the radiators on site.
- Q18: Hot Water Heater Intake & Venting Please clarify who is responsible for the HW heater intake & vent systems?
- R18: Mechanical Contractor, as per mechanical plans.
- Q19: I was going over the counts for this print and noticed that there is a track Lighting (TR3) listed on the print, however it is not listed on the Light Schedule (Print E2.2). Please advise when you get this. I appreciate your help and look forward to hearing from you.
- R19: The TR3 in question is found on Sheet E1.2 in northwest corner of Children (Room 206). TR3 is a 3'-0" length of track similar to TR6, TR9, RT10, and TR12. "TR" indicates a track, and the number corresponds to the length. They are all to be provided with the same accessories. The number of heads for all TR's are shown in plan.
- Q20: For the new louvers in the basement areaway I don't see any new lintels shown on any of the plans, structural, arch, or HVAC. Assuming they should be provided and installed by the GC, louvers by HVAC. Please clarify.
- R20: Louver openings at the areaway at Mechanical Room (Room 006) are saw cut into reinforced concrete. Lintels are not required.



Building Renovation for Haverford Township Free Library Addendum No. 3 Bernardon Project No. 7010.03-22

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Page 6

Q21: Ref. Dwgs. LP-100 and 4/LP-200


Good morning, our fence contractor contacted me questioning the perimeter property fence he wanted to confirm the type of fence you wanted there.

Drawing Detail 4/LP-200 is showing 6' High Aluminum Screen Fence is this what you are looking for around the property, same as the Dumpster Enclosure Gates.

I do see a 6' Chain Link Fence Detail on Sheet 5 of 10 of the Civil Drawing is this what you are looking for?

Can you please provide a detail of the trash enclosure, Drawing A1.1 references the Civil Drawing that is showing a different layout with the (2)5' gates.

- R21: The chain link fence detail is intended for temporary fencing during construction. The permanent property fence and trash enclosure fence should follow the aluminum fence details on the landscape plans/specs. Permanent fence is to be 6'-0" high. The size of the enclosure is to follow that shown on sheet A1.1 at 5-0""x14'-0", and the gate is to have two (2) 5 foot wide leaves. Gate details are on the landscape plan.
- Q22: Verifying that the Owner of the project is Haverford Township and NOT Haverford Township Free Library as stated on the cover sheet?
- R22: Correct. All the Prime Contracts will be with Haverford Township, not the Library. Haverford Township owns the building/property.
- Q23: To clarify, there is no "Owner provided RCO form." This information is required in the Qualification Statement number 5?
- R23: The "Bidder Qualification Statement", identified in the Project Manual Table of Contents as 004500E *Bidder Qualification Statement*, and which is the same form identified in the Bid Form as Attachment E is the "Owner provided RCO form". By filling out the Bidder Qualification Statement the bidder will have completed the RCO form.
- Q:24: The Instructions to Bidders and Bid Form state that an AIA A305 Qualification Form is to be submitted upon award. Later on in the Bid Form, it lists that an AIA A305 Qualification Form is to be submitted with the bid. Please clarify if an AIA A305 Qualification Form is to be submitted at all, since the Spec contains a separate "Bidder Qualification Statement."
- R24: The Project Manual references two qualification statement forms, the AIA A305 and the "Bidder Qualification Statement" identified in the Project Manual Table of Contents as 004500E *Bidder Qualification Statement*, and which is the same form identified in the Bid Form as Attachment E. Bidders are not required to provide an executed AIA A305 unless requested by the Owner at a later date. Bidders are required to attach an executed Attachment E Bidder Qualification Statement to their Bid Form as indicated.

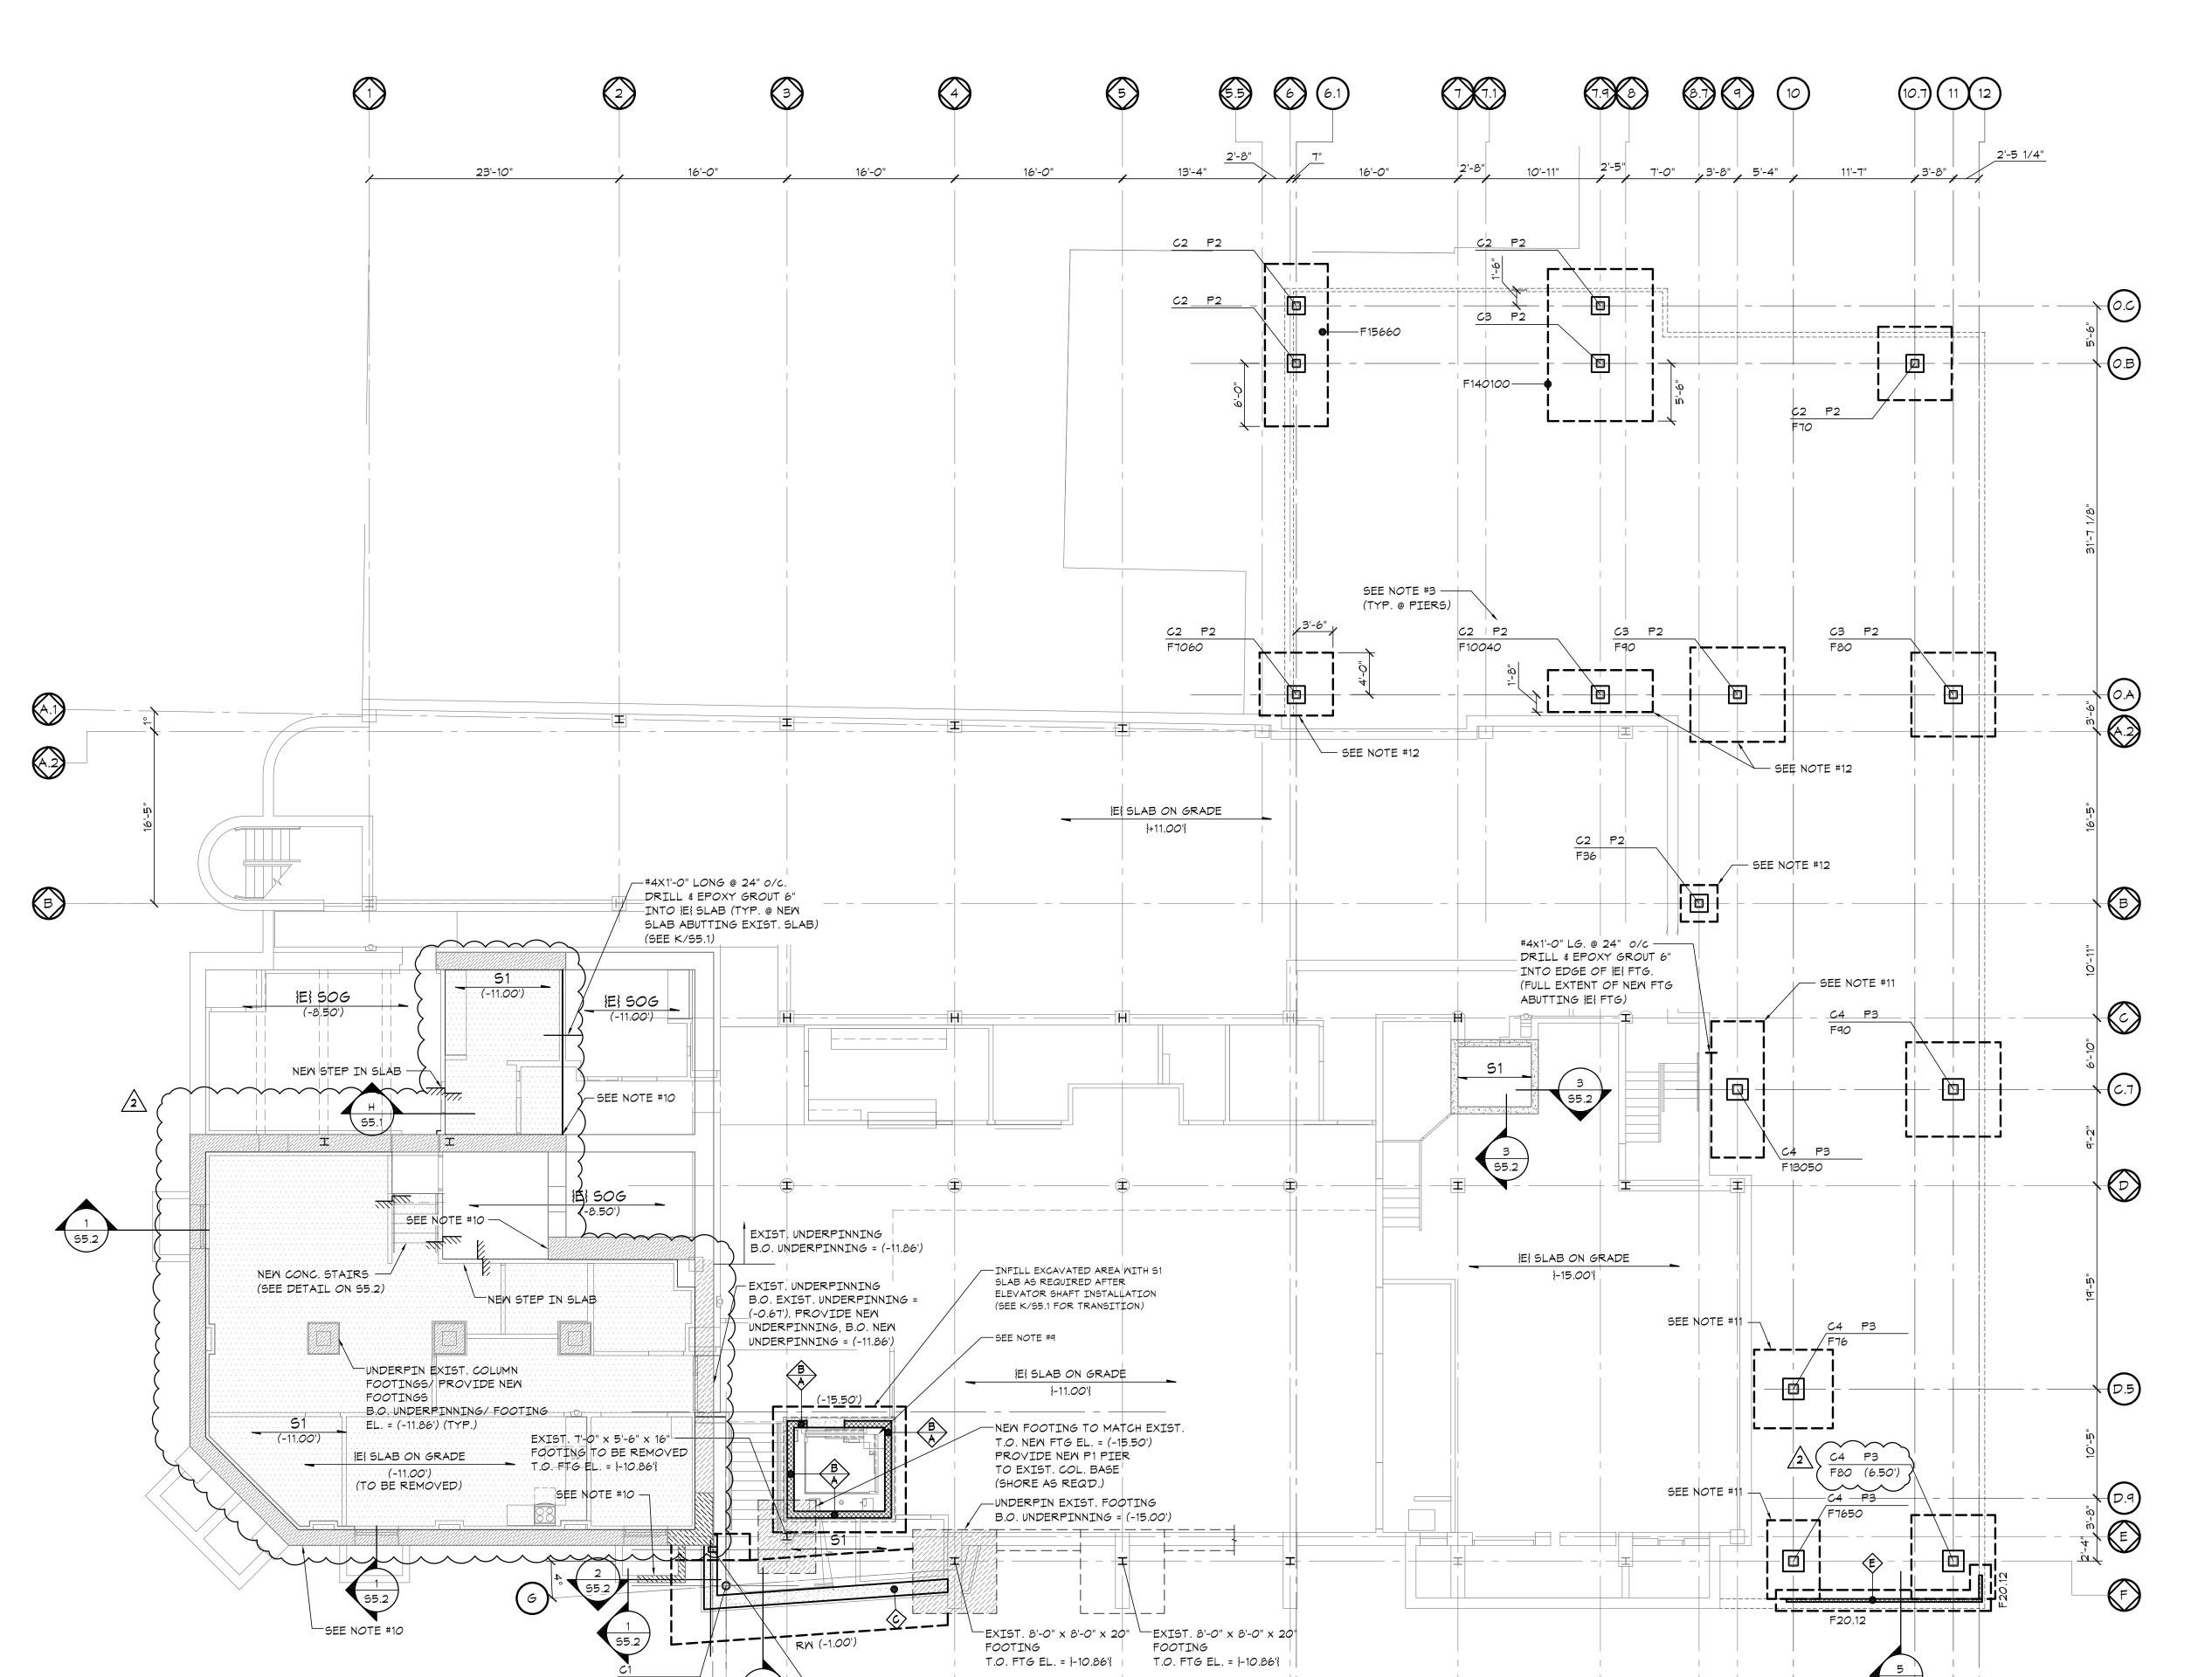

SCALE: 1/8" = 1'-0"

FOUNDATION PLAN

1. SEE PLAN FOR TOP OF SLAB EL. RELATIVE TO 288.36' DATUM.

2

2. TOP OF FOOTING EL. = (2.67') BELOW GRADE UNLESS NOTED OTHERWISE THUS (...).

COORDINATE ALL UNDER SLAB PIPING WITH ARCHITECTURAL/MECHANICAL DRAWINGS.

6. COORDINATE ALL DIMENSIONS WITH ARCHITECTURAL DRAWINGS PRIOR TO BUILDING LAYOUT.
7. '(*)' INDICATES DIMENSION TO BE VERIFIED W/ ELEVATOR MANUFACTURER PRIOR TO BUILDING LAYOUT.
8. 'RW_' INDICATES RETAINING WALL. SEE SECTIONS INDICATED FOR ADDITIONAL INFORMATION.

4. 'S_/ D_' INDICATES FLOOR/ ROOF CONSTRUCTION. SEE FLOOR/ ROOF CONSTRUCTION SCHEDULE ON THIS SHEET FOR ADDITIONAL

9. PROVIDE 2'-0" x 2'-0" x 2'-0" DEEP SUMP PIT. COORDINATE DIMENSIONS W/ ARCHITECTURAL AND MECHANICAL DIMENSIONS.

11. B.O. NEW FOOTING TO MATCH B.O. ADJACENT EXISTING FOOTING (= APPROX. -15.19', TO BE VERIFIED IN FIELD).

12 B.O NEW FOOTING TO MAICH B.O. ADJACENT EXISTING FOOTING (= APPROX. -2.97', TO BE VERIFIED IN FIELD).

(13. INDICATES EXISTING S.O.G. TO BE REMOVED.)

10. NEW UNDERPINNING AT EXISTING STONE FOUNDATION WALL. B.O. UNDERPINNING = (-11.86') (UNDERPINNING SCOPE IS DELEGATED).

3. TOP OF PIER EL. = [-0.67'] BELOW GRADE UNLESS NOTED OTHERWISE THUS [...].

	MALL SCHEDULE	
MARK	DESCRIPTION	WIDTH
А	12" REINF. CONC.	12"
В	8" CMU	7-5/8"
C	15" REINF. CONC.	15"
D	6" CFMF WALL	6"
E	4" CMU	3-5/8"

FLOOF	R/ ROOF CONSTRUC	CTION SCHEDULE
MARK	SECTION	DESCRIPTION
51		4" NORMAL WEIGHT CONCRETE SLAB ON GRADE W/ 6x6-W1.4x1.4 WMF OVER 4" CRUSHED STONE
S1A		4" NORMAL WEIGHT CONCRETE (W/ 6% AIR ENTRAINMENT) SLAB ON GRADE W/ 6x6-W1.4x1.4 WWF OVER 4" CRUSHED STONE
52		2 1/2" NORMAL WEIGHT CONCRETE ON 1 1/2" 20GA. LOK-FLOOR COMPOSITE DECK W/ 6x6-W1.4x1.4 WWF (4" TOTAL THICKNESS)
53		2 1/2" NORMAL WEIGHT CONCRETE ON 1 1/2" 20GA. LOK-FLOOR COMPOSITE DECK W/ 6x6-W1.4x1.4 WWF + 2" LW CONCRETE TOPPING (6" TOTAL THICKNESS)
D1	<i>-</i> ~~~~	1 1/2" 20GA. WIDE RIB METAL ROOF DECK (PAINTED)
D2		3/4" STRUCTO-CRETE DECKING FLOOR
D3		5/8" T&G PLYWOOD ROOF SHEATHING

PRICING NOTE: THESE DOCUMENTS REPRESENT THE CURRENT STATE OF A DEVELOPING DESIGN AND AS SUCH, NOT ALL CONDITIONS ARE CURRENTLY SHOWN. ALL STRUCTURAL DETAILS AND CONNECTIONS SHOULD BE ACCOUNTED FOR IN THE GENERAL CONTRACTOR PRICE AND SCOPE OF SERVICES, WHETHER THE SPECIFICS OF THESE CONDITIONS ARE SHOWN OR NOT SHOWN ON THESE DOCUMENTS

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JOB NUMBER: 22191-0254 JOB CONTACT: S. KRUMENACKER

Proiect:

HAVERFORD TOWNSHIP FREE LIBRARY 1601 Darby Road Haverford Township Havertown, PA 19083

Owner:

HAVERFORD TOWNSHIP FREE LIBRARY 1601 Darby Road Haverford Township Havertown, PA 19083

Revision/Issue:

0 05/31/2023 - Issued for Permit 1 09/30/2023 - Issued for Bidding 2 10/10/2023 - Addendum 3


Drawn: CAD
Reviewed: HVB
Contact: H. Bands
Project Number: 7010 03-22

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Sheet Title:

FOUNDATION PLAN

Sheet Number:

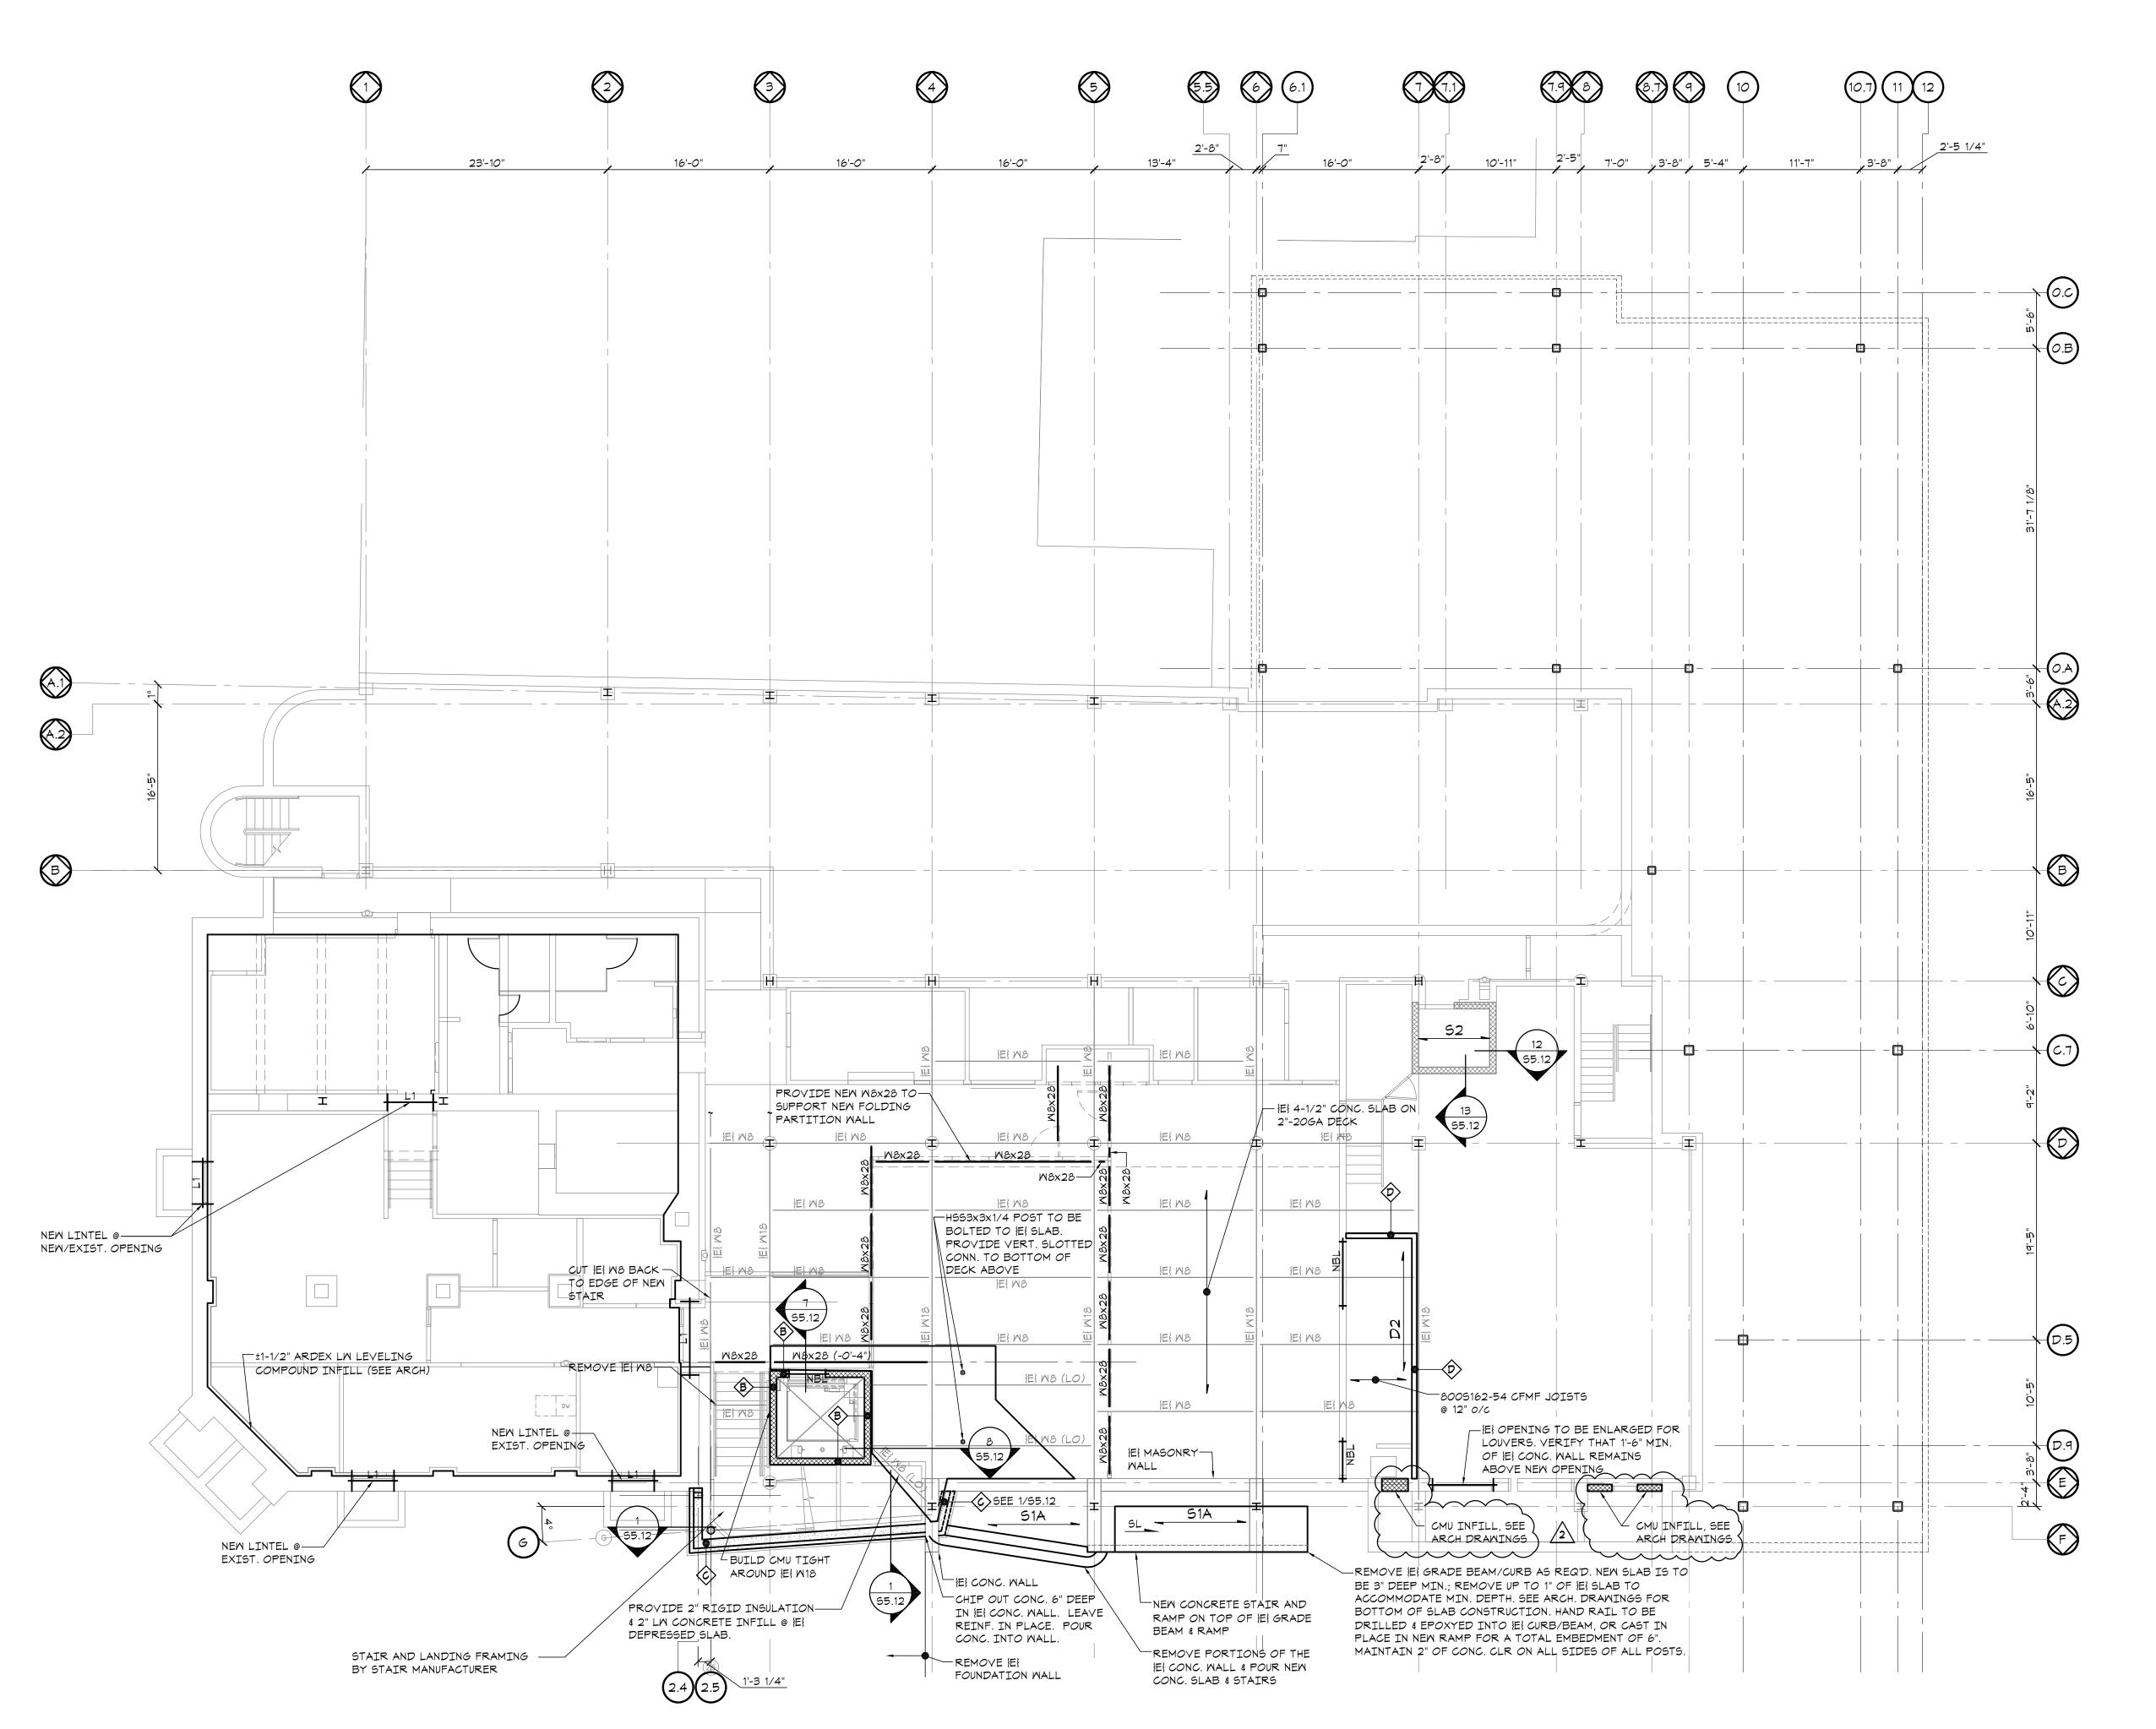

SCALE: 1/8" = 1'-0"

FIRST FLOOR FRAMING PLAN

ALL STEEL FOR WF MEMBERS SHALL BE ASTM A992.

2. TOP OF STEEL EL. = TO MATCH EXISTING EL.

TOP OF SLAB EL. = (288.36') = DATUM EL. = (0.00') UNLESS NOTED OTHERWISE THUS (...).

4. 'L_' INDICATES LINTEL. SEE SCHEDULE ON DRAWING SO.4 FOR ADDITIONAL INFORMATION.


5. 'NBL' INDICATES NON-BEARING LINTEL. SEE SCHEDULE ON DRAWING SO.4 FOR ADDITIONAL INFORMATION.

3. 'S_/ D_' INDICATES FLOOR/ ROOF CONSTRUCTION. SEE FLOOR/ ROOF CONSTRUCTION SCHEDULE ON THIS SHEET FOR ADDITIONAL

1 'PU- 'INDICATES POST-UP, SEE POST UP SCHEDULE ON SO.4 FOR ADDITIONAL INFORMATION.

8. AT ALL NEW CONNECTIONS TO EXISTING CMU, CONTRACTOR TO VERIFY EXISTING MASONRY IS GROUTED. CONTRACTOR TO GROUT

ANY HOLLOW CELLS BEFORE INSTALLING FASTENERS.

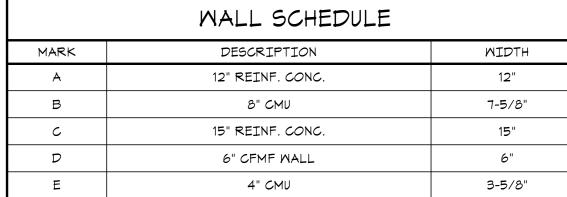

FLOOF	R/ROOF CONSTRUC	CTION SCHEDULE
MARK	SECTION	DESCRIPTION
5 1		4" NORMAL WEIGHT CONCRETE SLAB ON GRADE W/ 6x6-W1.4x1.4 WMF OVER 4" CRUSHED STONE
S1A		4" NORMAL MEIGHT CONCRETE (W/ 6% AIR ENTRAINMENT) SLAB ON GRADE W/ 6x6-M1.4x1.4 MMF OVER 4" CRUSHED STONE
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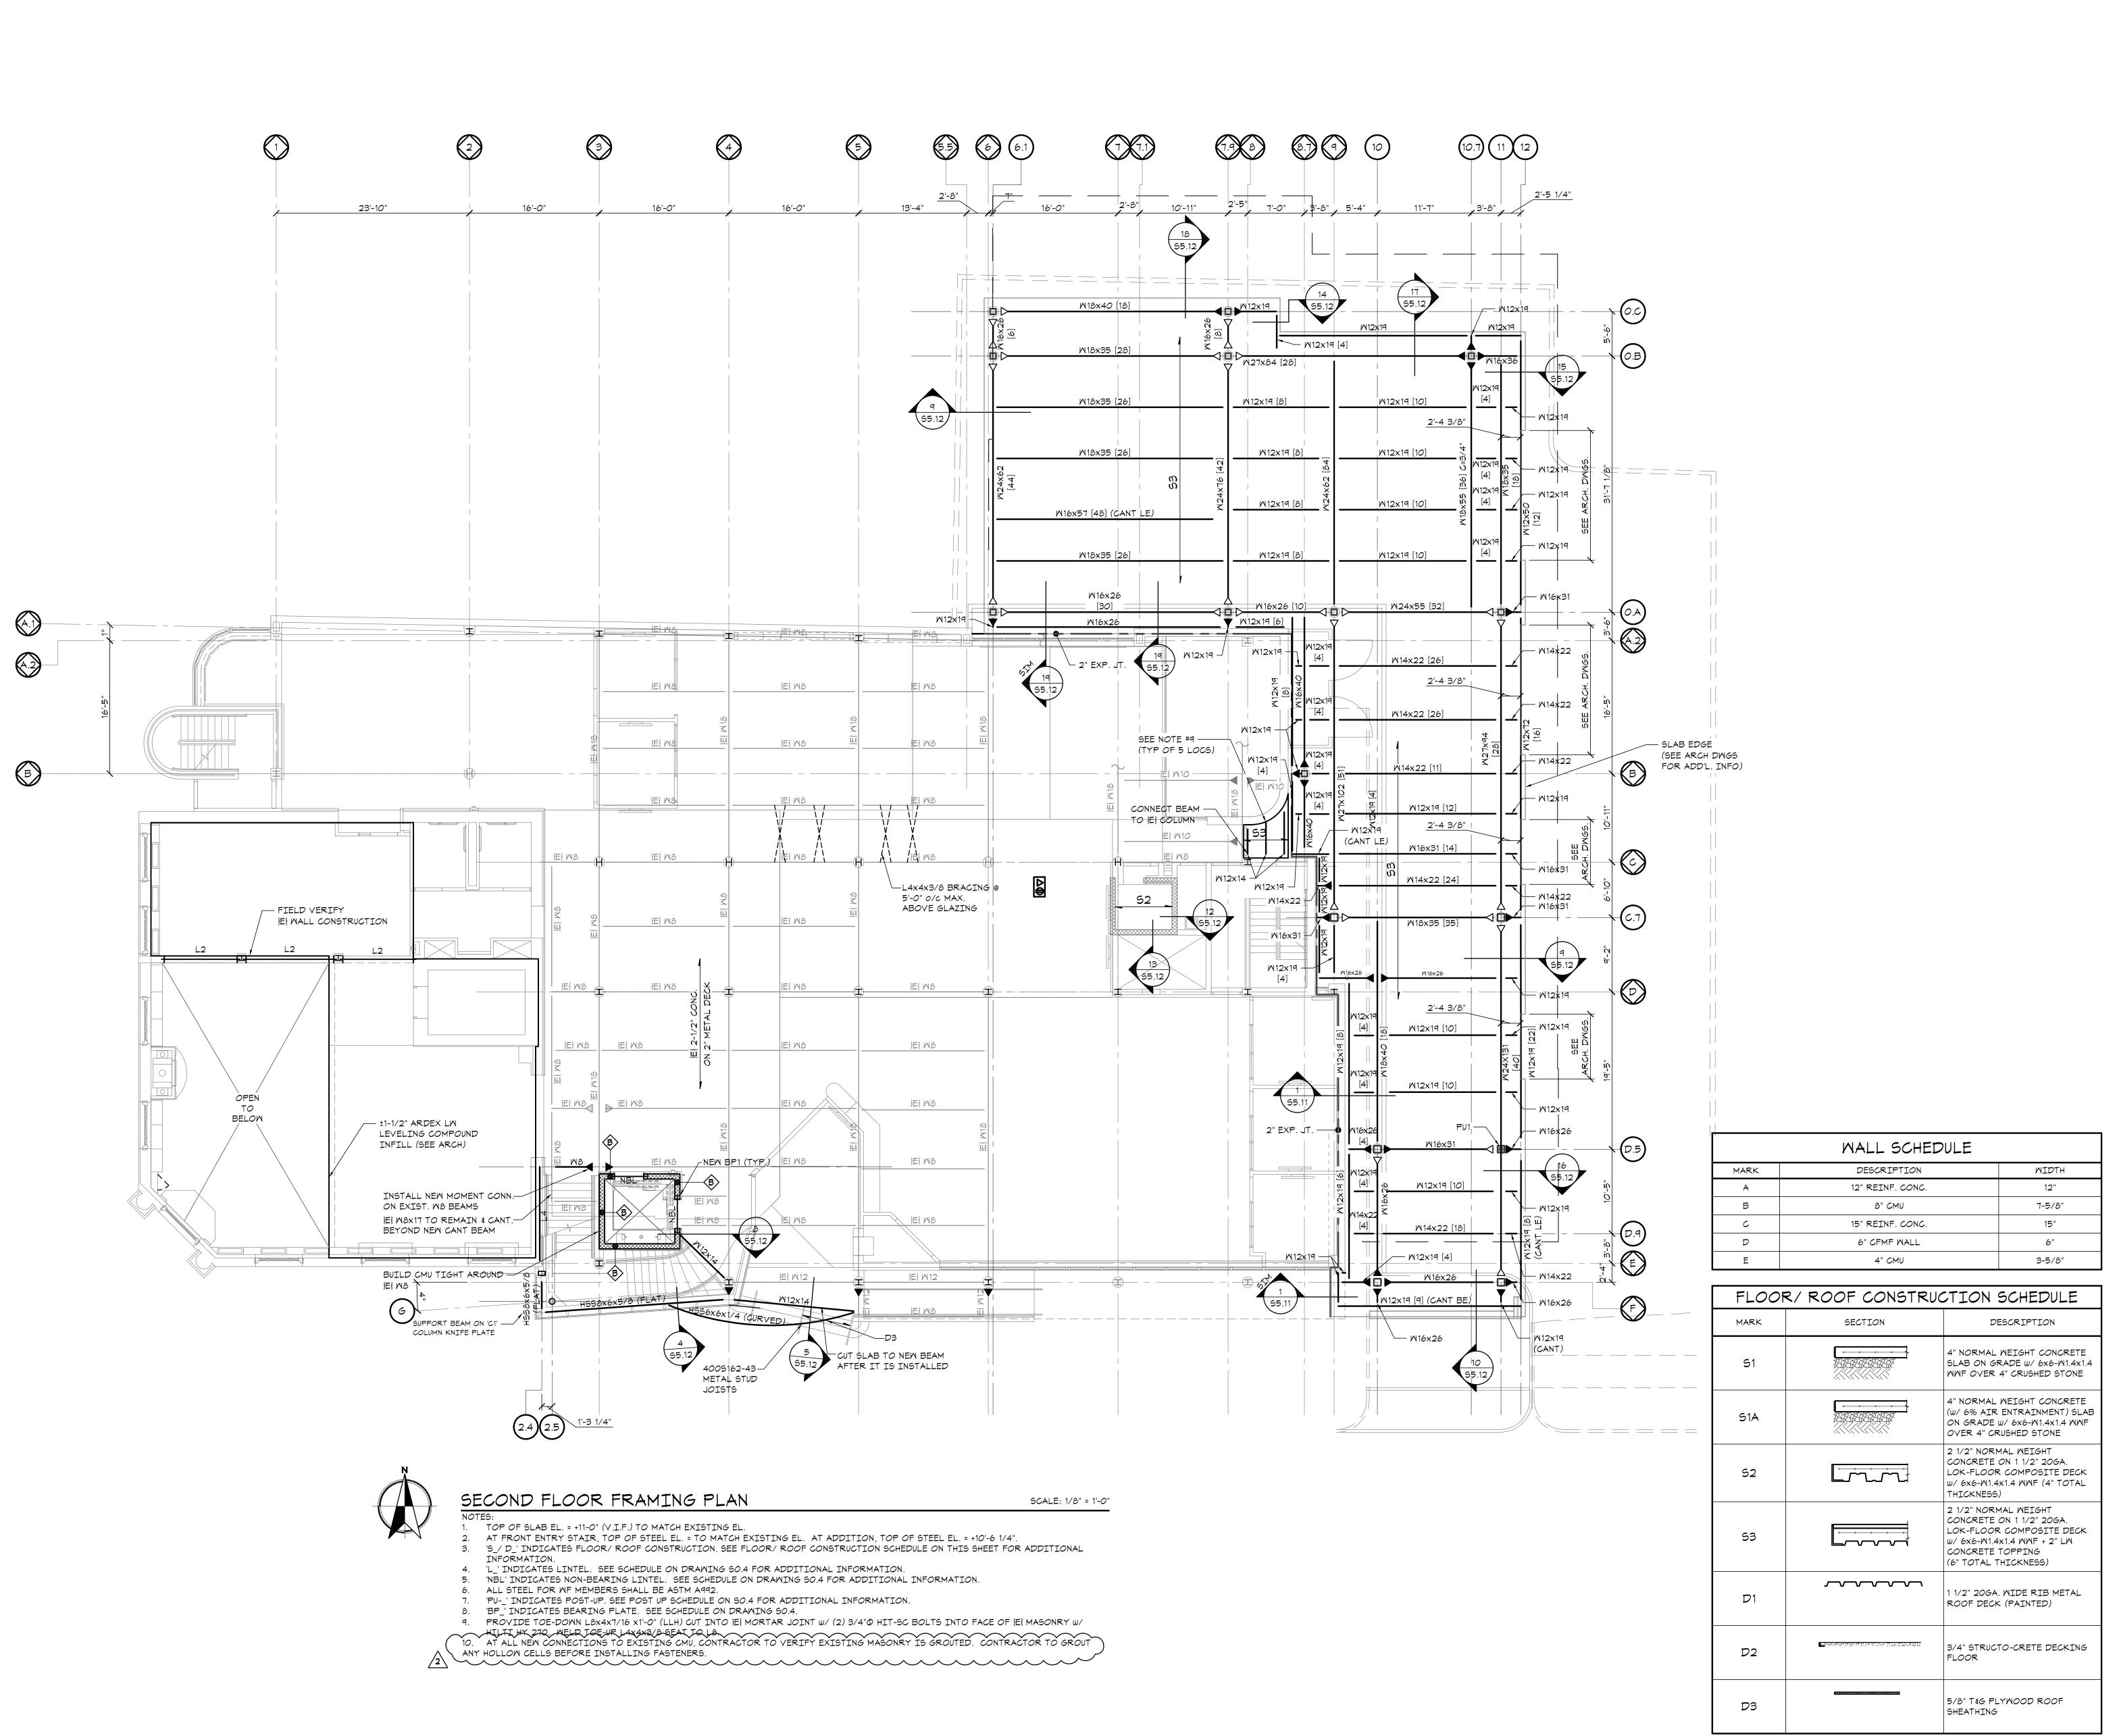
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FIRST FLOO

FIRST FLOOR FRAMING PLAN

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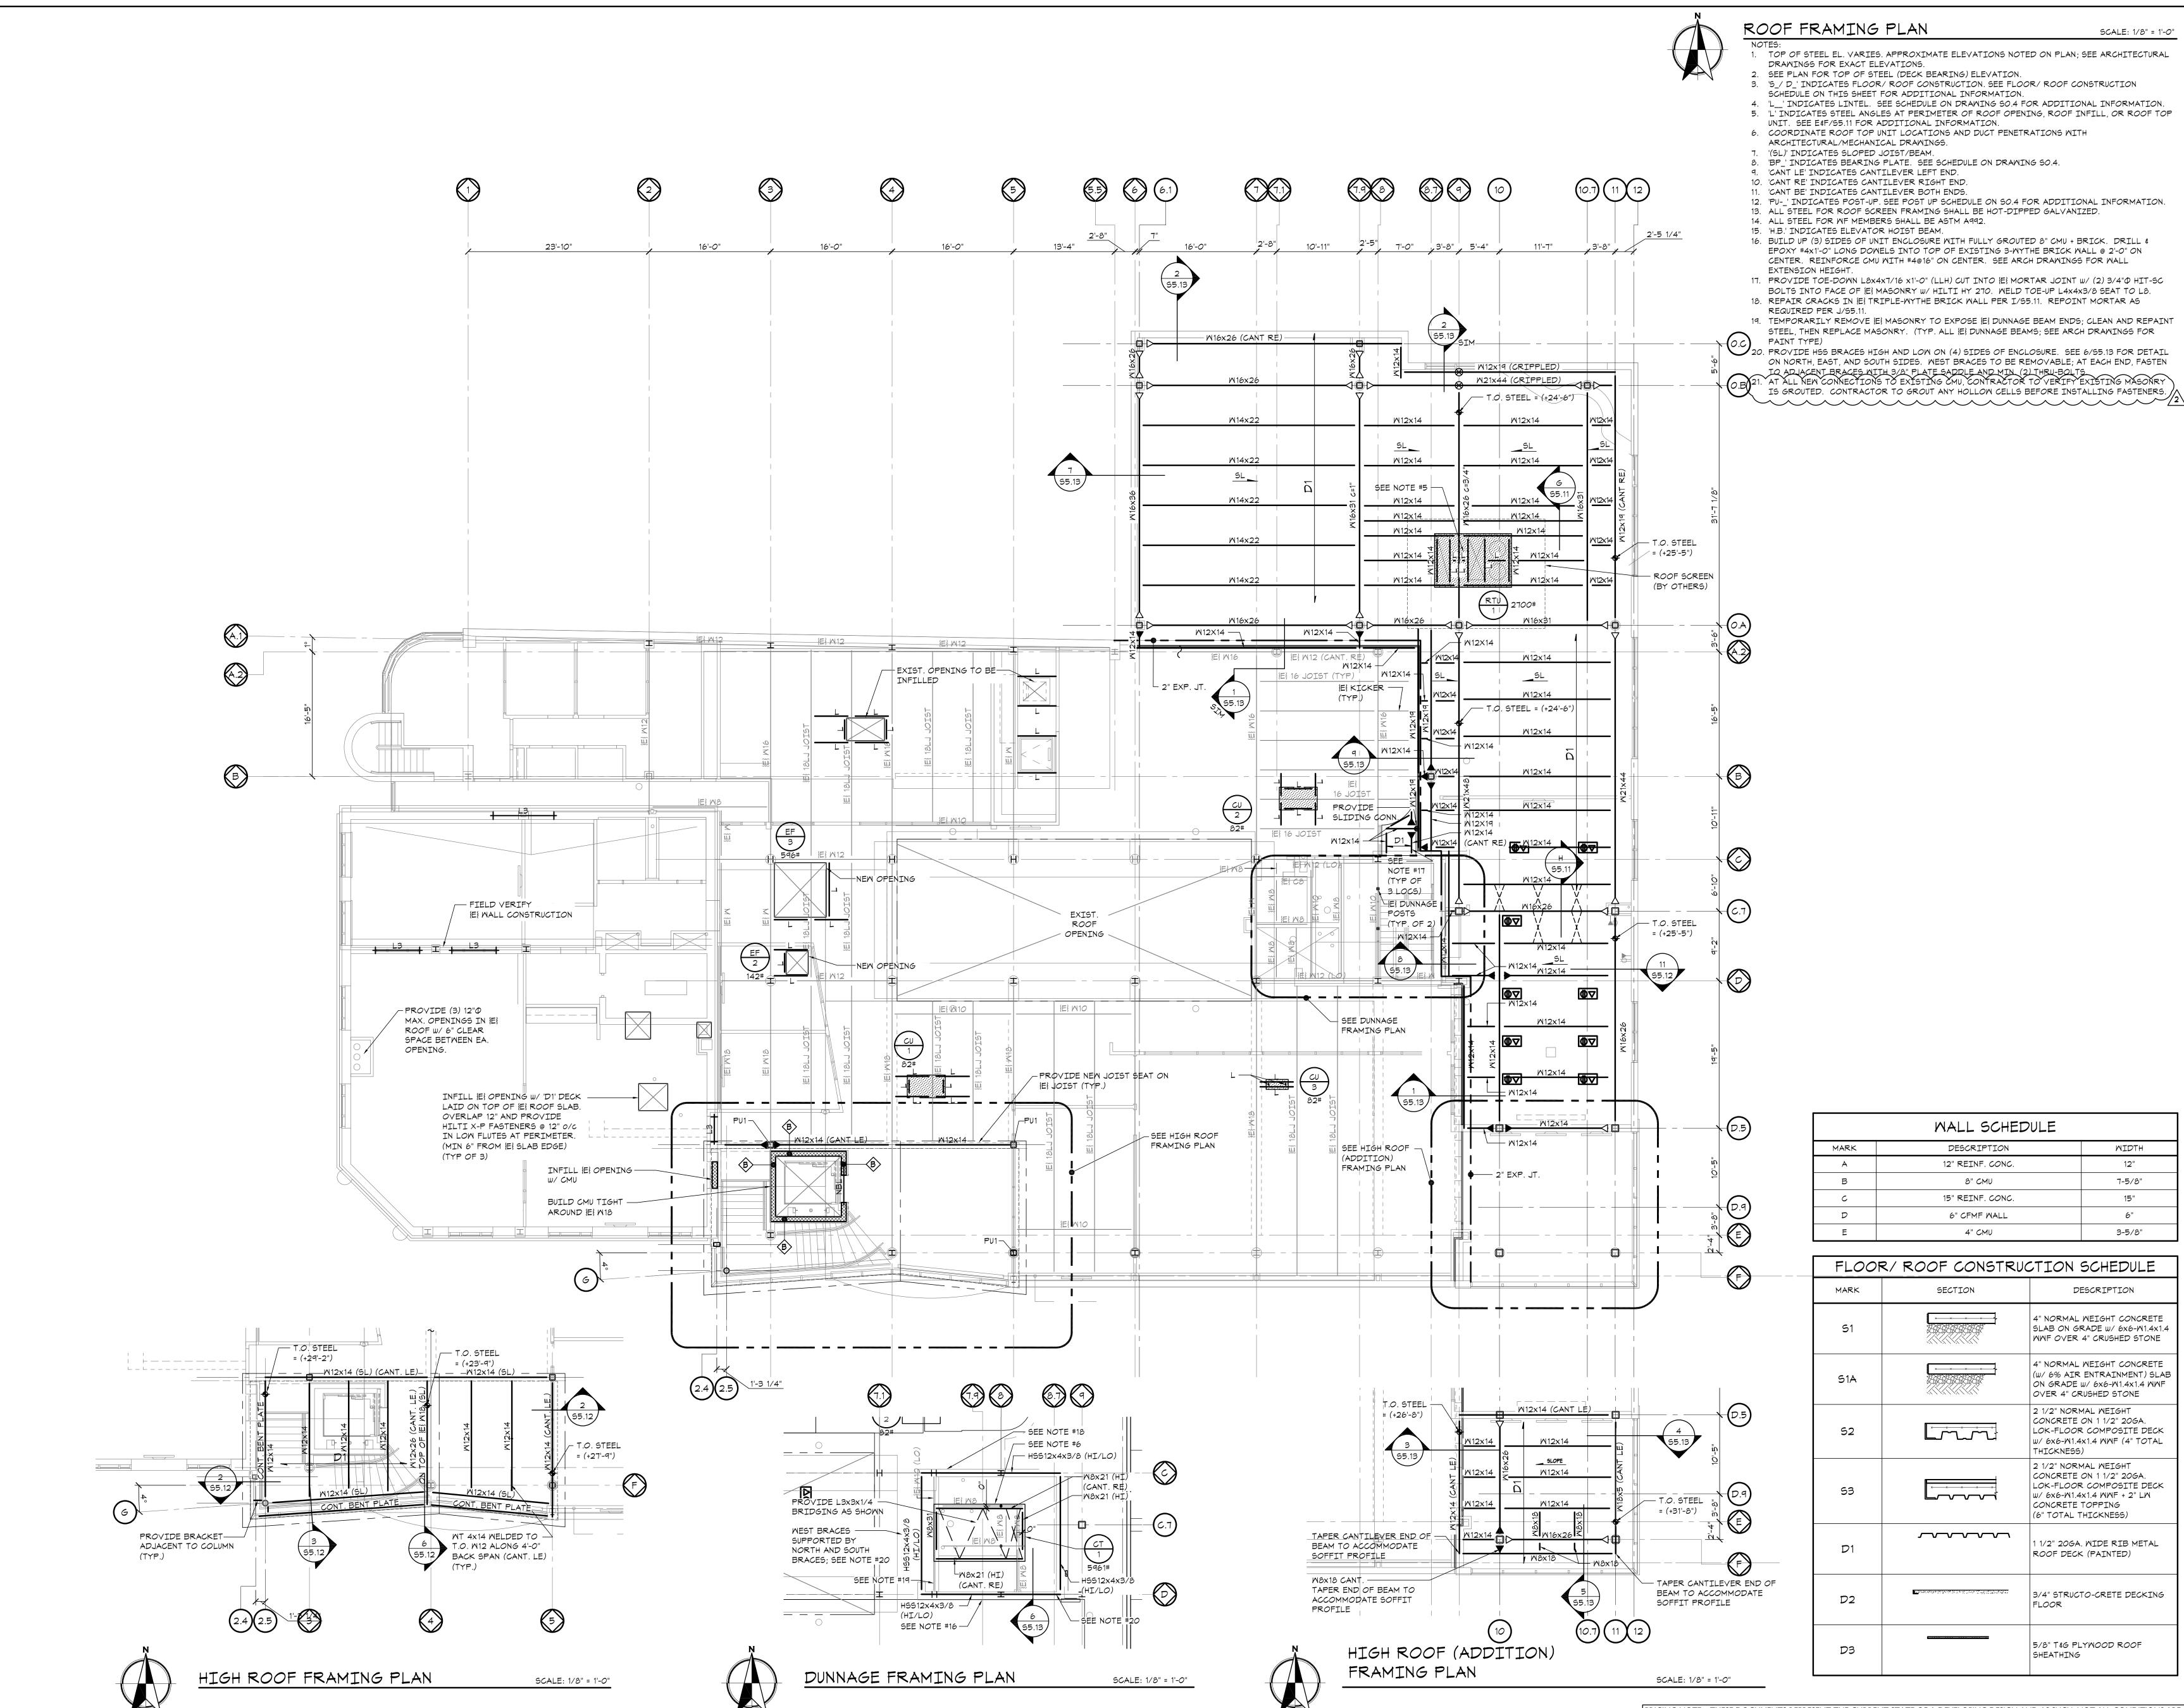
Sheet Title:

SECOND FLOOR FRAMING PLAN

Sheet Number:

\$1.2
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Owner:

MIDTH

12"

7-5/8"

3-5/8"

DESCRIPTION

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Reviewed: Contact: Project Number: 7010.03-22

Sheet Title:

ROOF & HIGH ROOF FRAMING PLAN

Sheet Number:

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PRICING NOTE: THESE DOCUMENTS REPRESENT THE CURRENT STATE OF A DEVELOPING DESIGN AND AS SUCH, NOT ALL CONDITIONS ARE CURRENTLY SHOWN. ALL STRUCTURAL DETAILS AND CONNECTIONS SHOULD BE ACCOUNTED FOR IN THE GENERAL CONTRACTOR PRICE AND SCOPE OF SERVICES, WHETHER THE SPECIFICS OF THESE CONDITIONS ARE SHOWN OR NOT SHOWN ON THESE DOCUMENTS

 ${\tt 2.~ALL~DEMOLISHED~MATERIALS~SHALL~BE~RECYCLED~WHEREVER~POSSIBLE.}\\$ ANY HAZARDOUS MATERIALS SHALL BE HANDLED ACCORDING TO

3. GENERAL CONTRACTOR TO PATCH/REPAIR EXISTING WALL/CEILINGS AS REQUIRED BY THE ARCHITECT.

GOVERNMENT REGULATION AND DISPOSED OF IN A SAFE MANNER.

4. THE SCOPE OF MECHANICAL DEMOLITION SHALL INCLUDE BUT NOT BE

LIMITED TO THE FOLLOWING: A. THE EXISTING AIR HANDLING UNITS, INCLUDING ALL EXISTING DUCTWORK AIR DEVICES, PIPING, HANGERS, WIRING AND CONTROLS.

B. ALL EXISTING DUCTWORK SYSTEMS, INCLUDING ALL HANGERS, AIR DEVICES AND ACCESSORIES. C.ALL EXISTING CHILLED AND HOT WATER PIPING SYSTEMS, INCLUDING ALL HANGERS, INSULATION, VALVES, AND ACCESSORIES.

D. ALL EXISTING EXHAUST AND SUPPLY FANS WITH ALL ITS ASSOCIATED CONTROLS AND ACCESSORIES.

E. ALL EXISTING FUEL OIL PIPING SYSTEMS WITH ALL ITS ASSOCIATED PIPING, TANKS, HANGERS, ETC.

F. ALL EXISTING PNEUMATIC CONTROLS AND ASSOCIATED TUBING, COMPRESSORS, FILTER-DRIERS, THERMOSTATS, ACTUATORS, SENSORS,

MECHANICAL DEMOLITION NOTES

(DM1) CONTRACTOR SHALL DISCONNECT AND REMOVE EXISTING AIR HANDLERS AND $^\prime$ ASSOCIATED DUCT MAINS TO POINT WHERE INDICATED ON THE DRAWINGS ALONG WITH ALL ASSOCIATED EXISTING DUCTWORK, HOUSEKEEPING PADS, AIR DEVICES. PIPING, CONTROL WIRING, AND POWER.

(DM2)CONTRACTOR SHALL DISCONNECT AND REMOVE THE EXISTING OUTSIDE AIR └── INTAKE LOUVER, DAMPER AND CONTROLS. CONTRACTOR TO PATCH/REPAIR EXISTING [WALL, CEILING] TO MATCH EXISTING CONDITIONS. CONTRACTOR TO COORDINATE ALL WORK WITH ARCHITECT AND GENERAL CONTRACTOR.

(DM3) CONTRACTOR SHALL DISCONNECT AND REMOVE EXISTING PUMP AND ASSOCIATED PIPING, CONTROL WIRING, CONCRETE HOUSING PAD, AND POWER.

(DM4) CONTRACTOR SHALL DEMOLISH ALL EXISTING DUCTWORK. GENERAL CONTRACTOR TO PATCH/REPAIR EXISTING WALL/CEILING TO MATCH EXISTING CONDITIONS. CONTRACTOR TO COORDINATE ALL WORK WITH ARCHITECT AND GENERAL CONTRACTOR.

(DM7) CONTRACTOR SHALL DEMOLISH THE EXISTING SUPPLY AND RETURN AIR DEVICES AND REPLACE WITH NEW. ALL NEW AIR DEVICES SHALL MATCH EXISTING TYPE, SIZES, MATERIAL AND COMPONENTS (OPPOSED BLADE DAMPER, ETC.), COORDINATE FINAL FINISH WITH ARCHITECT. CONTRACTOR TO FURNISH AND INSTALL NEW BRANCH DUCTWORK AND ASSOCIATED VOLUME DAMPERS.

(DM8) CONTRACTOR SHALL REMOVE/DEMOLISH EXISTING WATER COOLED CHILLER ALONG WITH ALL ASSOCIATED CONTROLS, ELECTRICAL, CONCRETE PAD, AND PIPING CONNECTIONS. EXISTING PIPING MAINS TO THE COOLING TOWER SHALL REMAIN AND BE INSULATED AND RE-PURPOSED TO SERVE CHILLED WATER TO THE NEW ROOFTOP AIR COOLED CHILLER.

CONTRACTOR SHALL REMOVE/DEMOLISH EXISTING AIR COMPRESSOR AND ALL ASSOCIATED PNEUMATIC CONTROLS.

DM10) CONTRACTOR SHALL DISCONNECT AND REMOVE EXISTING HOT WATER (IBASEBOARD, SILL TYPE, EXTENDED FIN, CABINET UNIT HEATERS INCLUDING [PIPING, ASSOCIATED CONTROL VALVE, PIPE INSULATION], POWER, CONTROL WIRING AND ACCESSORIES. GENERAL CONTRACTOR TO PATCH/REPAIR EXISTING WALL/CEILING TO MATCH EXISTING CONDITIONS. CONTRACTOR TO COORDINATE ALL WORK WITH ARCHITECT AND GENERAL CONTRACTOR.

2. ALL DEMOLISHED MATERIALS SHALL BE RECYCLED WHEREVER POSSIBLE. ANY HAZARDOUS MATERIALS SHALL BE HANDLED ACCORDING TO GOVERNMENT REGULATION AND DISPOSED OF IN A ______ PLUMBING DEMOLITION KEYNOTES: P1 REMOVE EXISTING WATER CLOSET, URINAL AND LAVATORY AND ALL ASSOCIATED DOMESTIC WATER AND SANITARY AND VENT PIPING BACK REMOVE EXISTING SERVICE SINK AND ALL ASSOCIATED DOMESTIC WATER AND SANITARY AND VENT PIPING BACK TO MAINS AND CAP. (DP3) REMOVE EXISTING ELECTRIC WATER COOLER AND ALL ASSOCIATED DOMESTIC WATER AND SANITARY AND VENT PIPING BACK TO MAINS AND $\langle_{ extsf{DP4}}
angle$ REMOVE EXISTING DOMESTIC HOT WATER, HOT WATER RETURN AND COLD WATER PIPING SYSTEM IN IT'S ENTIRETY, AND ALL ASSOCIATED FITTINGS, HANGERS, VALVES, SLEEVES AND ETC. (DP5) REMOVE EXISTING DOMESTIC HOT WATER HEATER AND ALL ASSOCIATED DOMESTIC WATER AND SANITARY AND VENT PIPING BACK TO MAINS AND $\langle extstyle e$ SANITARY AND VENT PIPING BACK TO MAINS AND CAP. 1. IT SHALL BE THE RESPONSIBILITY OF THE DEMOLITION CONTRACTOR TO VISIT THE SITE IN ORDER TO BEST UNDERSTAND THE SCOPE OF THE DEMOLITION WORK. 2. ALL DEMOLISHED MATERIALS SHALL BE RECYCLED WHEREVER POSSIBLE. ANY HAZARDOUS MATERIALS SHALL BE HANDLED ACCORDING TO GOVERNMENT REGULATION AND DISPOSED OF 3. THE SCOPE OF PLUMBING DEMOLITION SHALL INCLUDE BUT NOT BE LIMITED TO THE FOLLOWING WHERE INDICATED NOT TO REMAIN: UNEXCAVATED a. THE EXISTING SANITARY AND VENT SYSTEM INCLUDING PIPING, HANGERS FITTINGS, SLEEVES, PUMPS, CONTROLS, WIRING, ETC. b. THE EXISTING DOMESTIC WATER SYSTEM INCLUDING ALL COLD WATER, HOT WATER SUPPLY AND HOT WATER RETURN PIPING, HANGERS, FITTINGS, VALVES, WATER HEATERS, TANKS, PUMPS, CONTROLS, WIRING, SLEEVES, BACKFLOW PREVENTERS, METERS, ETC. - REMOVE EXISTING SINK AND DISH WASHER c. ALL EXISTING FIXTURES, FAUCETS, FLUSH VALVES, TRAPS, HANGERS, STOPS, ETC. AND ALL ASSOCIATED PLUMBING REMOVE EXISTING 208V-3Ø-4W[⊥]225AMP-REMOVE EXISTING 208V-3Ø-4W+225AMP-REMOVE EXISTING FIRE ALARM CONTROL -PANEL AND ASSOCIATED DISCONNECTING MEANS AND TURN OVER TO THE OWNER. EXISTING EXPANSION TANK TO _____ EXISTING DISCONNECTS FOR BOILERS AND ASSOCIATED DM4 DE1 DM7 CIRCULATORS TO REMAIN REMOVE EXISTING BOILER VENT AND INTAKE PIPING CURRENTLY EXTENDING TO THE SIDEWALL _____ VENTS IN ORDER TO BE RE-ROUTED TO THE ROOF. COORDINATE ALL LOW VOLTAGE -DEMOLITION REQUIREMENTS WITH THE LOW VOLTAGE CONSULTANT'S PLANS COMPANY METER AND SPECIFICATIONS (CONVERGENT) #017458282 — — — — — ALL EQUIPMENT BEING DEMOLISHED IN *\$* THIS AREA IS TO BE TURNED OVER TO REMOVE EXISTING BELL-THE OWNER. EXISTING 13.2 KV-3Ø LOAD BREAK DE4 TELEPHONE EQUIPMENT. EXISTING DIRECT VENT BOILER AND ASSOCIATED CIRCULATORS EXISTING DOMESTIC WATER BUILDING SYSTEM TO BE AND "NEW" PIPING TO REMAIN. CONTRACTOR SHALL CARRY AN DEMOLISHED IN IT'S ENTIRETY, AND REMOVE ALL EXISTING 300KVA-208Y/12ØV ASSOCIATED HANGERS, VALVES, PARTS OF THE SYSTEM SECONDARY TRANSFORMER ALLOWANCE OF \$10,000 TO IN BUILDING. ADJUST LOCATION OF BOILERS — EXISTING C.T. CABINET DE6 SHOULD IT PROVE NECESSARY TO KEEP REQUIRED - EXISTING 208V-3Ø-4W-1000AMP COMMUNITY ROOM CLEARANCES. EXISTING DISCONNECTING MEANS TO MAIN DISTRIBUTION PANEL. REMAIN. — REMOVE EXISTING 208V-3Ø-4W-400A *++++1 EXISTING 208V-3Ø-4W-400A — REMOVE EXISTING 208V-3Ø⊢4W-40DA - REMOVE EXISTING WATER DM4 PANEL "PX-C" SERVICE AND ASSOCIATED PIPING IN THIS AREA - REMOVE EXISTING ATS REMOVE EXISTING CATV— - REMOVE EXISTING 208V-30-4W-100A REMOVE EXISTING 208V-3Ø-4W-100A EQUIPMENT. PANEL "LE" __SPLIT_BUS__PANEL_"LX"__ - REMOVE EXISTING 200AMP EMERGENCY GENERATOR REMOVE EXISTING 200AMP REMOVE ALL REMOVE EXISTING SUMP PUMP EXISTING LOUVERS TO BE REPLACED. EXISTING AND DAMPERS FOR SUMP PIT TO REMAIN REPLACEMENT. - REMOVE EXISTING GENERATOR VENT COMPLETELY REMOVE EXISTING COMPRESSOR REMOVE EXISTING 32KW/40KVA— EXISTING OIL STORAGE SYSTEM, TANK & PIPING TO BE 208V-3Ø PAD MOUNTED FOR PNEUMATIC CONTROLS. REMOVED. EXISTING FUEL SUMP PIT & UNDERGROUND STORAGE TANK TO BE REMOVED & FILLED IN EXISTING WATER COOLED -ACCORDANCE WITH FEDERAL & STATE EPA GUIDELINES. CHILLER TO BE REMOVED AND COORDINATE THIS WORK WITH CIVIL CONTRACTOR. REFER SALVAGED. AND TURNED OVER TO CIVIL DRAWINGS FOR ADD'L INFO. TO OWNER FOR RESALE. CONTRACTOR SHALL TRANSPORT CHILLER TO TOWNSHIP STORAGE FACILITY AS INSTRUCTED BY



BASEMENT DEMO FLOOR PLAN - MECH/PLUMB/ELECT

LECTRICAL DEMOLITION KEYNOTES

 $\langle _{
m DE1} \rangle$ UNLESS OTHERWISE NOTED, ALL EXISTING ELECTRICAL DEVICES, EQUIPMENT, LUMINAIRES, CONTROLS, FIRE ALARM \checkmark DEVICES AND EQUIPMENT, ETC. IN THIS AREA ARE TO BE REMOVED. ALL ASSOCIATED WIRING METHODS (CONDUIT AND WIRE) ARE TO BE REMOVED TO THEIR POINT OF ORIGIN. ALL DEMOLISHED EQUIPMENT IS TO BE TURNED OVER TO THE OWNER FOR SALVAGE.

 $\langle \text{DE2} \rangle$ INDICATES EXISTING GENERATOR TO BE REMOVED. REMOVE ALL ASSOCIATED ATS EQUIPMENT, WIRING METHODS, └── DISCONNECT EQUIPMENT, PANELBOARDS, ETC. COORDINATE ALL GENERATOR DEMOLITION WORK WITH ALL OTHER

DE3 UNLESS OTHERWISE NOTED, ALL EXISTING ELECTRICAL DEVICES, EQUIPMENT, LUMINAIRES, CONTROLS, FIRE ALARM DEVICES AND EQUIPMENT, ETC. IN THIS AREA ARE TO BE EXISTING TO REMAIN.

 $\langle_{ extsf{DE4}}
angle$ INDICATES EXISTING MECHANICAL EQUIPMENT TO REMAIN. UNLESS OTHERWISE NOTED, ALL EXISTING DISCONNECT └── EQUIPMENT IS TO REMAIN. WIRING METHODS ARE TO REMAIN OR BE REFED VIA NEW PANELBOARD EQUIPMENT.

 $\langle DE5 \rangle$ INDICATES EXISTING HOT WATER HEATER TO BE REMOVED. REMOVE ALL WIRING METHODS TO POINT OF ORIGIN.

(DE6) INDICATES EXISTING DISCONNECTING MEANS ASSOCIATED WITH MECHANICAL EQUIPMENT TO BE REMOVED. REMOVE ALL ── WIRING METHODS TO POINT OF ORIGIN.

UNLESS OTHERWISE NOTED, THE ENTIRE ELECTRICAL SYSTEM IS TO BE REMOVED. ELECTRICAL CONTRACTOR IS TO VERIFY ALL EXISTING CONDITIONS IN FIELD PRIOR ANY WORK.

2. REMOVE BRANCH CIRCUIT WIRING METHODS BACK TO POWER SOURCE OR TO ITS NEAREST ACTIVE DEVICE. ALL CIRCUITS SERVING THE EXISTING AREAS THAT ARE INTERRUPTED BY DEMOLITION WORK ARE TO BE RE-ENERGIZED TO MAINTAIN BRANCH CIRCUIT CONTINUITY.

3. TAG ALL OVERCURRENT PROTECTION DEVICES THAT BECOME "SPARE" AS A RESULT OF DEMOLITION WORK, PROVIDE NEW, TYPED PANELBOARD DIRECTORIES FOR ALL DISTRIBUTION AND BRANCH CIRCUIT EQUIPMENT IMPACTED BY THE RENOVATION WORK.

4. REMOVE CONDUCTORS AND PROVIDE PULL-STRINGS AND CAP OPENINGS AND CONDUITS THAT ARE NOT TO BE REUSED.

5. ALL POWER SHUTDOWNS ARE TO BE SCHEDULED AND COORDINATED WITH OWNER.

6. IT IS THE INTENT FOR POWER TO REMAIN ACTIVE IN THE EXISTING TO REMAIN AREAS DURING CONSTRUCTION. CONTRACTOR IS TO MODIFY EXISTING WIRING ARRANGEMENT TO COMPLY.

7. IT IS THE INTENT TO REMOVE ALL ELECTRICAL DEVICES WHICH INTERFERE WITH THE NEW CONSTRUCTION WORK OR DEMOLITION WORK WHETHER SPECIFICALLY IDENTIFIED OR NOT.

8. ALL EXISTING INCOMING SERVICE WIRING METHODS, TRANSFORMER, C.T. AND METERING, AND MAIN DISTRIBUTION PANEL EQUIPMENT ARE TO REMAIN. EXISTING OVERCURRENT PROTECTION DEVICES ARE TO BE REUSED TO SERVE NEW PANELBOARD EQUIPMENT AS INDICATED ON THE NEW WORK PLANS. PROVIDE NEW FEEDER WIRING METHODS AS

9. REFER TO NEW WORK PLANS FOR ADDITIONAL INFORMATION.

10. COORDINATE ALL DEMOLISHED EQUIPMENT THAT IS TO BE TURNED OVER TO THE OWNER.

THE DELIVERY OF THIS DRAWING SHOULD NOT BE CONSTRUED TO PROVIDE AN EXPRESS WARRANTY OR GUARANTEE TO ANYONE THAT ALL THE DIMENSIONS AND DETAILS ARE EXACT OR TO INDICATE THAT THE USE OF THIS DRAWING IMPLIES THE REVIEW AND APPROVAL BY THE DESIGN PROFESSIONAL OF ANY FUTURE USE. ANY USE OF THIS INFORMATION WITHOUT THE WRITTEN APPROVAL BY THE DESIGN PROFESSIONAL IS AT THE SOLE RISK AND LIABILITY OF THE USER. THE DESIGN PROFESSIONAL RESERVES THE RIGHT TO REMOVE OUR PROFESSIONAL SEAL AND/OR TITLE BLOCK.

THE SCHEDULES AND DRAWINGS REPRESENT ONLY CERTAIN REQUIREMENTS OF THE PROJECT. THERE ARE ADDITIONAL REQUIREMENTS IN THE SPECIFICATIONS BOOKLET WHICH THE CONTRACTOR IS BOUND TO PROVIDE. A SUPPLIER OR CONTRACTOR'S PRICING, WHICH IS BASED ONLY ON DRAWINGS OR SCHEDULES, MAY LEAVE IMPORTANT COSTS UNACCOUNTED FOR WHICH WILL ULTIMATELY BE THE CONTRACTOR OR SUPPLIER'S RESPONSIBILITY TO PROVIDE.

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GENERAL PLUMBING DEMOLITION NOTES:

1. IT SHALL BE THE RESPONSIBILITY OF THE DEMOLITION CONTRACTOR

TO VISIT THE SITE IN ORDER TO BEST UNDERSTAND THE SCOPE OF THE

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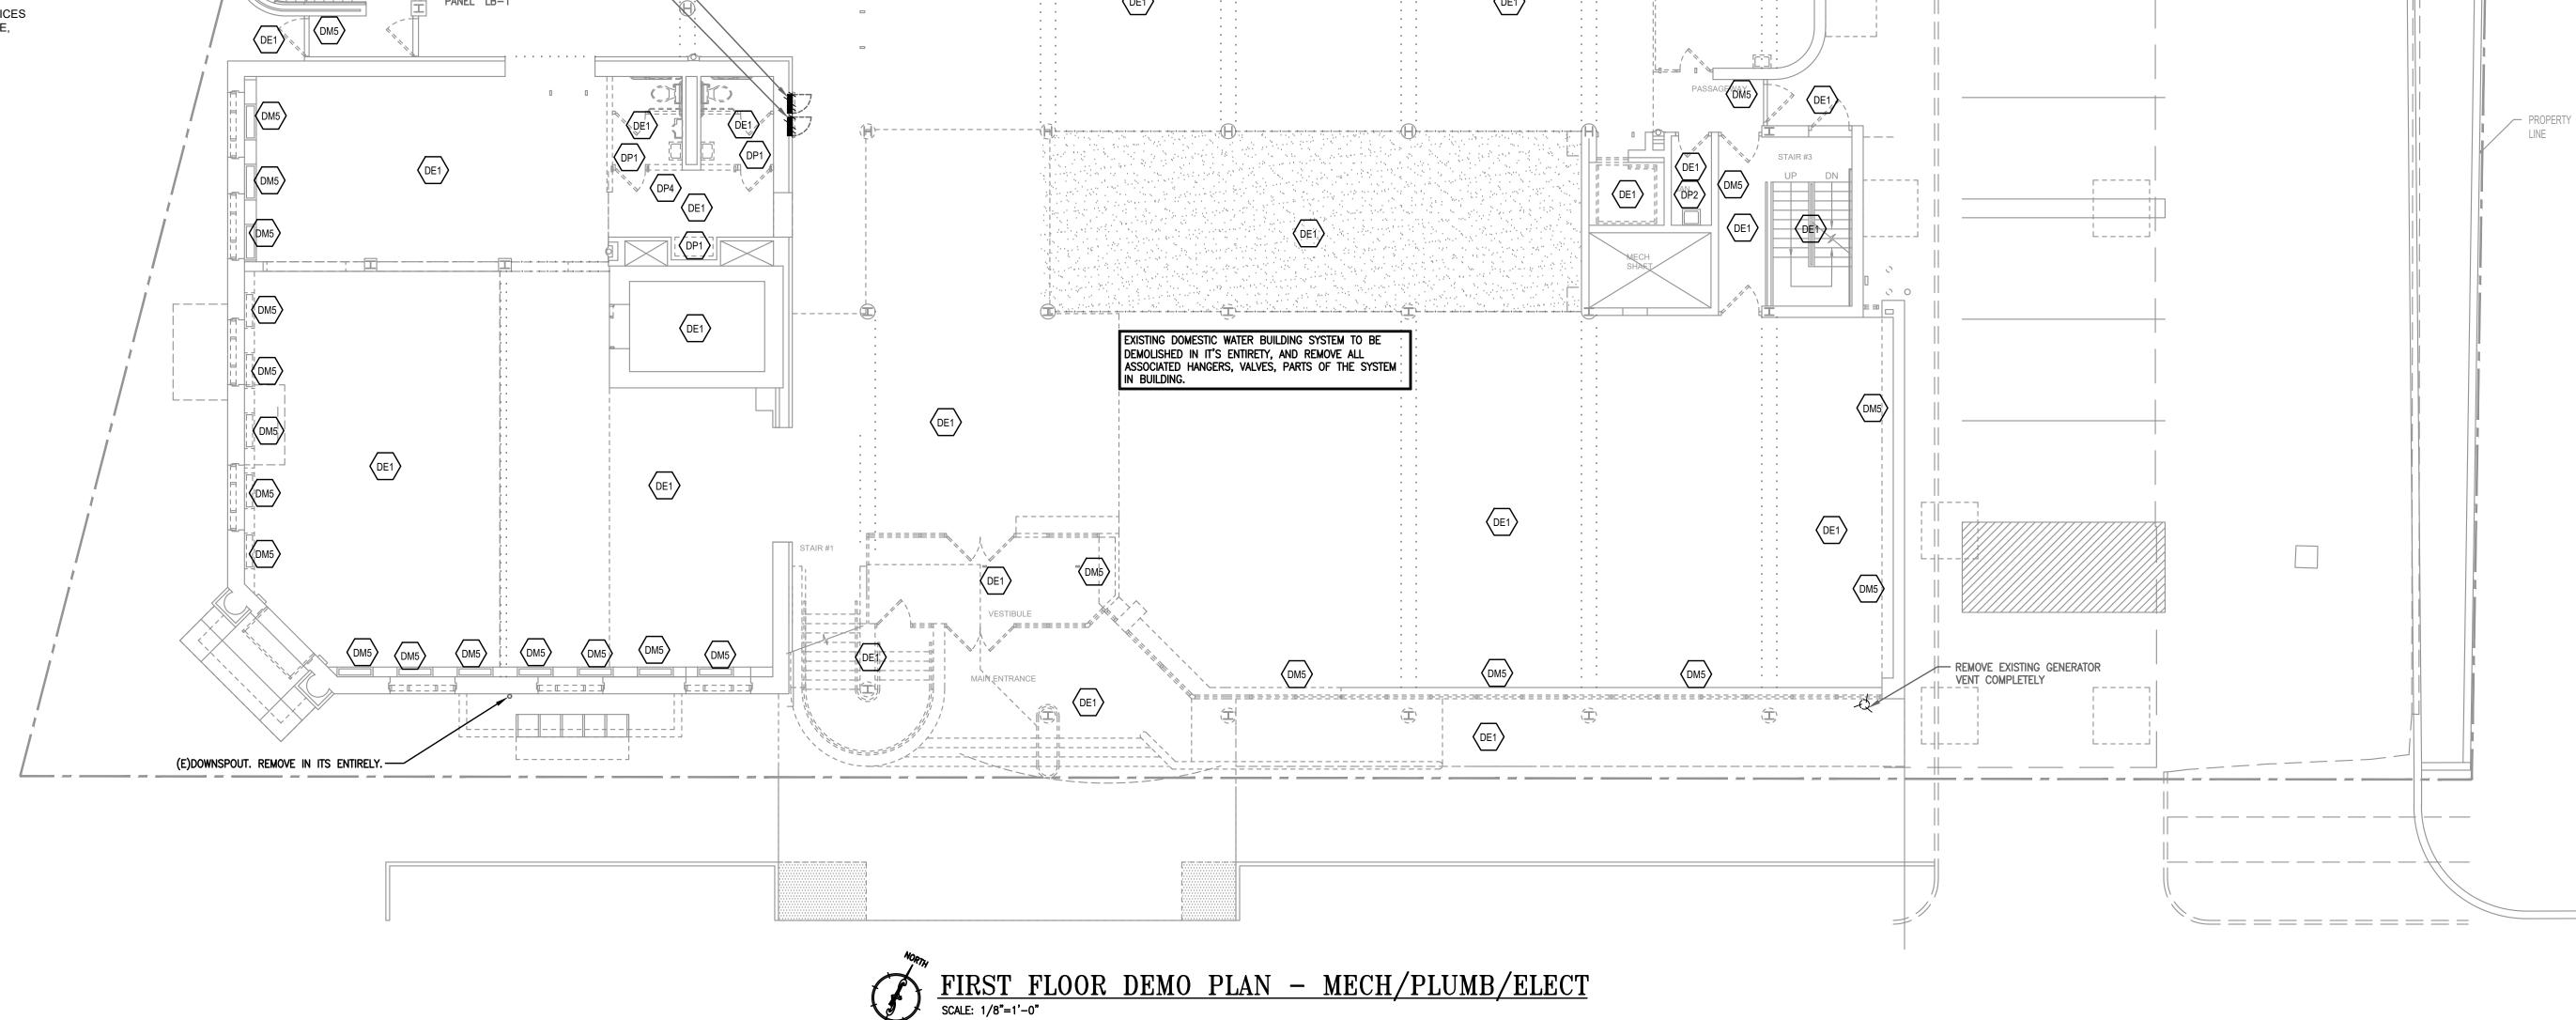
Issued for Permit 1 09/20/23 Issued for Bidding 2 10/04/23 Addendum 3

Reviewed: Contact: Chris Keenan Project Number: 7010.03-22

Sheet Title:

BASEMENT DEMO FLOOR PLAN - M/P/E

Sheet Number:



ELECTRICAL DEMOLITION KEYNOTES:

 $_{\text{DE1}}$ UNLESS OTHERWISE NOTED, ALL EXISTING ELECTRICAL DEVICES, EQUIPMENT, LUMINAIRES, CONTROLS, FIRE ALARM — DEVICES AND EQUIPMENT, ETC. IN THIS AREA ARE TO BE REMOVED. ALL ASSOCIATED WIRING METHODS ARE TO BE REMOVED TO THEIR POINT OF ORIGIN.

 $\langle DE2 \rangle$ INDICATES EXISTING GENERATOR TO BE REMOVED. REMOVE ALL ASSOCIATED ATS EQUIPMENT, WIRING METHODS, DISCONNECT EQUIPMENT, PANELBOARDS, ETC. COORDINATE ALL GENERATOR DEMOLITION WORK WITH ALL OTHER TRADES. ALL DEMOLISHED EQUIPMENT IS TO BE TURNED OVER TO THE OWNER FOR SALVAGE.

 $\langle DE3 \rangle$ UNLESS OTHERWISE NOTED, ALL EXISTING ELECTRICAL DEVICES, EQUIPMENT, LUMINAIRES, CONTROLS, FIRE ALARM DEVICES AND EQUIPMENT, ETC. IN THIS AREA ARE TO BE EXISTING TO REMAIN.

\(\int_{DE4}\)\) INDICATES EXISTING MECHANICAL EQUIPMENT TO REMAIN. UNLESS OTHERWISE NOTED, ALL EXISTING DISCONNECT EQUIPMENT AND WIRING METHODS ARE TO REMAIN.

 $\langle DE5 \rangle$ INDICATES EXISTING HOT WATER HEATER TO BE REMOVED. REMOVE ALL WIRING METHODS TO POINT OF ORIGIN.

(DE6) INDICATES EXISTING DISCONNECTING MEANS ASSOCIATED WITH MECHANICAL EQUIPMENT TO BE REMOVED. REMOVE ALL

ELECTRICAL DEMOLITION NOTES:

1. ELECTRICAL CONTRACTOR IS TO VERIFY ALL EXISTING CONDITIONS IN FIELD PRIOR ANY WORK.

2. REMOVE BRANCH CIRCUIT WIRING METHODS BACK TO POWER SOURCE OR TO ITS NEAREST ACTIVE DEVICE. ALL CIRCUITS SERVING THE EXISTING AREAS THAT ARE INTERRUPTED BY DEMOLITION WORK ARE TO BE RE-ENERGIZED TO MAINTAIN BRANCH CIRCUIT CONTINUITY.

3. TAG ALL OVERCURRENT PROTECTION DEVICES THAT BECOME "SPARE" AS A RESULT OF DEMOLITION WORK. PROVIDE NEW, TYPED PANELBOARD DIRECTORIES FOR ALL DISTRIBUTION AND BRANCH CIRCUIT EQUIPMENT IMPACTED BY THE

4. REMOVE CONDUCTORS AND PROVIDE PULL-STRINGS AND CAP OPENINGS AND CONDUITS THAT ARE NOT TO BE REUSED.

5. ALL POWER SHUTDOWNS ARE TO BE SCHEDULED AND COORDINATED WITH OWNER.

DEMOLITION WORK WHETHER SPECIFICALLY IDENTIFIED OR NOT.

6. IT IS THE INTENT FOR POWER TO REMAIN ACTIVE IN THE EXISTING TO REMAIN AREAS DURING CONSTRUCTION.

CONTRACTOR IS TO MODIFY EXISTING WIRING ARRANGEMENT TO COMPLY. 7. IT IS THE INTENT TO REMOVE ALL ELECTRICAL DEVICES WHICH INTERFERE WITH THE NEW CONSTRUCTION WORK OR

8. ALL EXISTING INCOMING SERVICE WIRING METHODS, TRANSFORMER, C.T. AND METERING, AND MAIN DISTRIBUTION PANEL EQUIPMENT IS TO REMAIN. EXISTING OVERCURRENT PROTECTION DEVICES ARE TO BE REMOVED AND REPLACED WITH NEW TO SERVE NEW PANELBOARD EQUIPMENT AS INDICATED ON THE NEW WORK PLANS. PROVIDE NEW FEEDER WIRING

METHODS AS REQUIRED. 10. COORDINATE ALL DEMOLISHED EQUIPMENT THAT IS TO BE TURNED OVER TO THE OWNER.

THE DELIVERY OF THIS DRAWING SHOULD NOT BE CONSTRUED TO PROVIDE AN EXPRESS WARRANTY OR GUARANTEE TO ANYONE THAT ALL THE DIMENSIONS AND DETAILS ARE EXACT OR TO INDICATE THAT THE USE OF THIS DRAWING IMPLIES THE REVIEW AND APPROVAL BY THE DESIGN PROFESSIONAL OF ANY FUTURE USE. ANY USE OF THIS INFORMATION WITHOUT THE WRITTEN APPROVAL BY THE DESIGN PROFESSIONAL IS AT THE SOLE RISK AND LIABILITY OF THE USER. THE DESIGN PROFESSIONAL RESERVES THE RIGHT TO REMOVE OUR PROFESSIONAL SEAL AND/OR TITLE BLOCK.

 OUTSIDE FACE OF NEW EXTERIOR WALL ABOVE

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<u>NOTICE</u> THE SCHEDULES AND DRAWINGS REPRESENT ONLY CERTAIN REQUIREMENTS OF THE PROJECT. THERE ARE ADDITIONAL REQUIREMENTS IN THE SPECIFICATIONS BOOKLET WHICH THE CONTRACTOR IS BOUND TO PROVIDE. A SUPPLIER OR CONTRACTOR'S PRICING, WHICH IS BASED ONLY ON DRAWINGS OR SCHEDULES, MAY LEAVE IMPORTANT COSTS UNACCOUNTED FOR WHICH WILL ULTIMATELY BE THE CONTRACTOR OR SUPPLIER'S RESPONSIBILITY TO PROVIDE.

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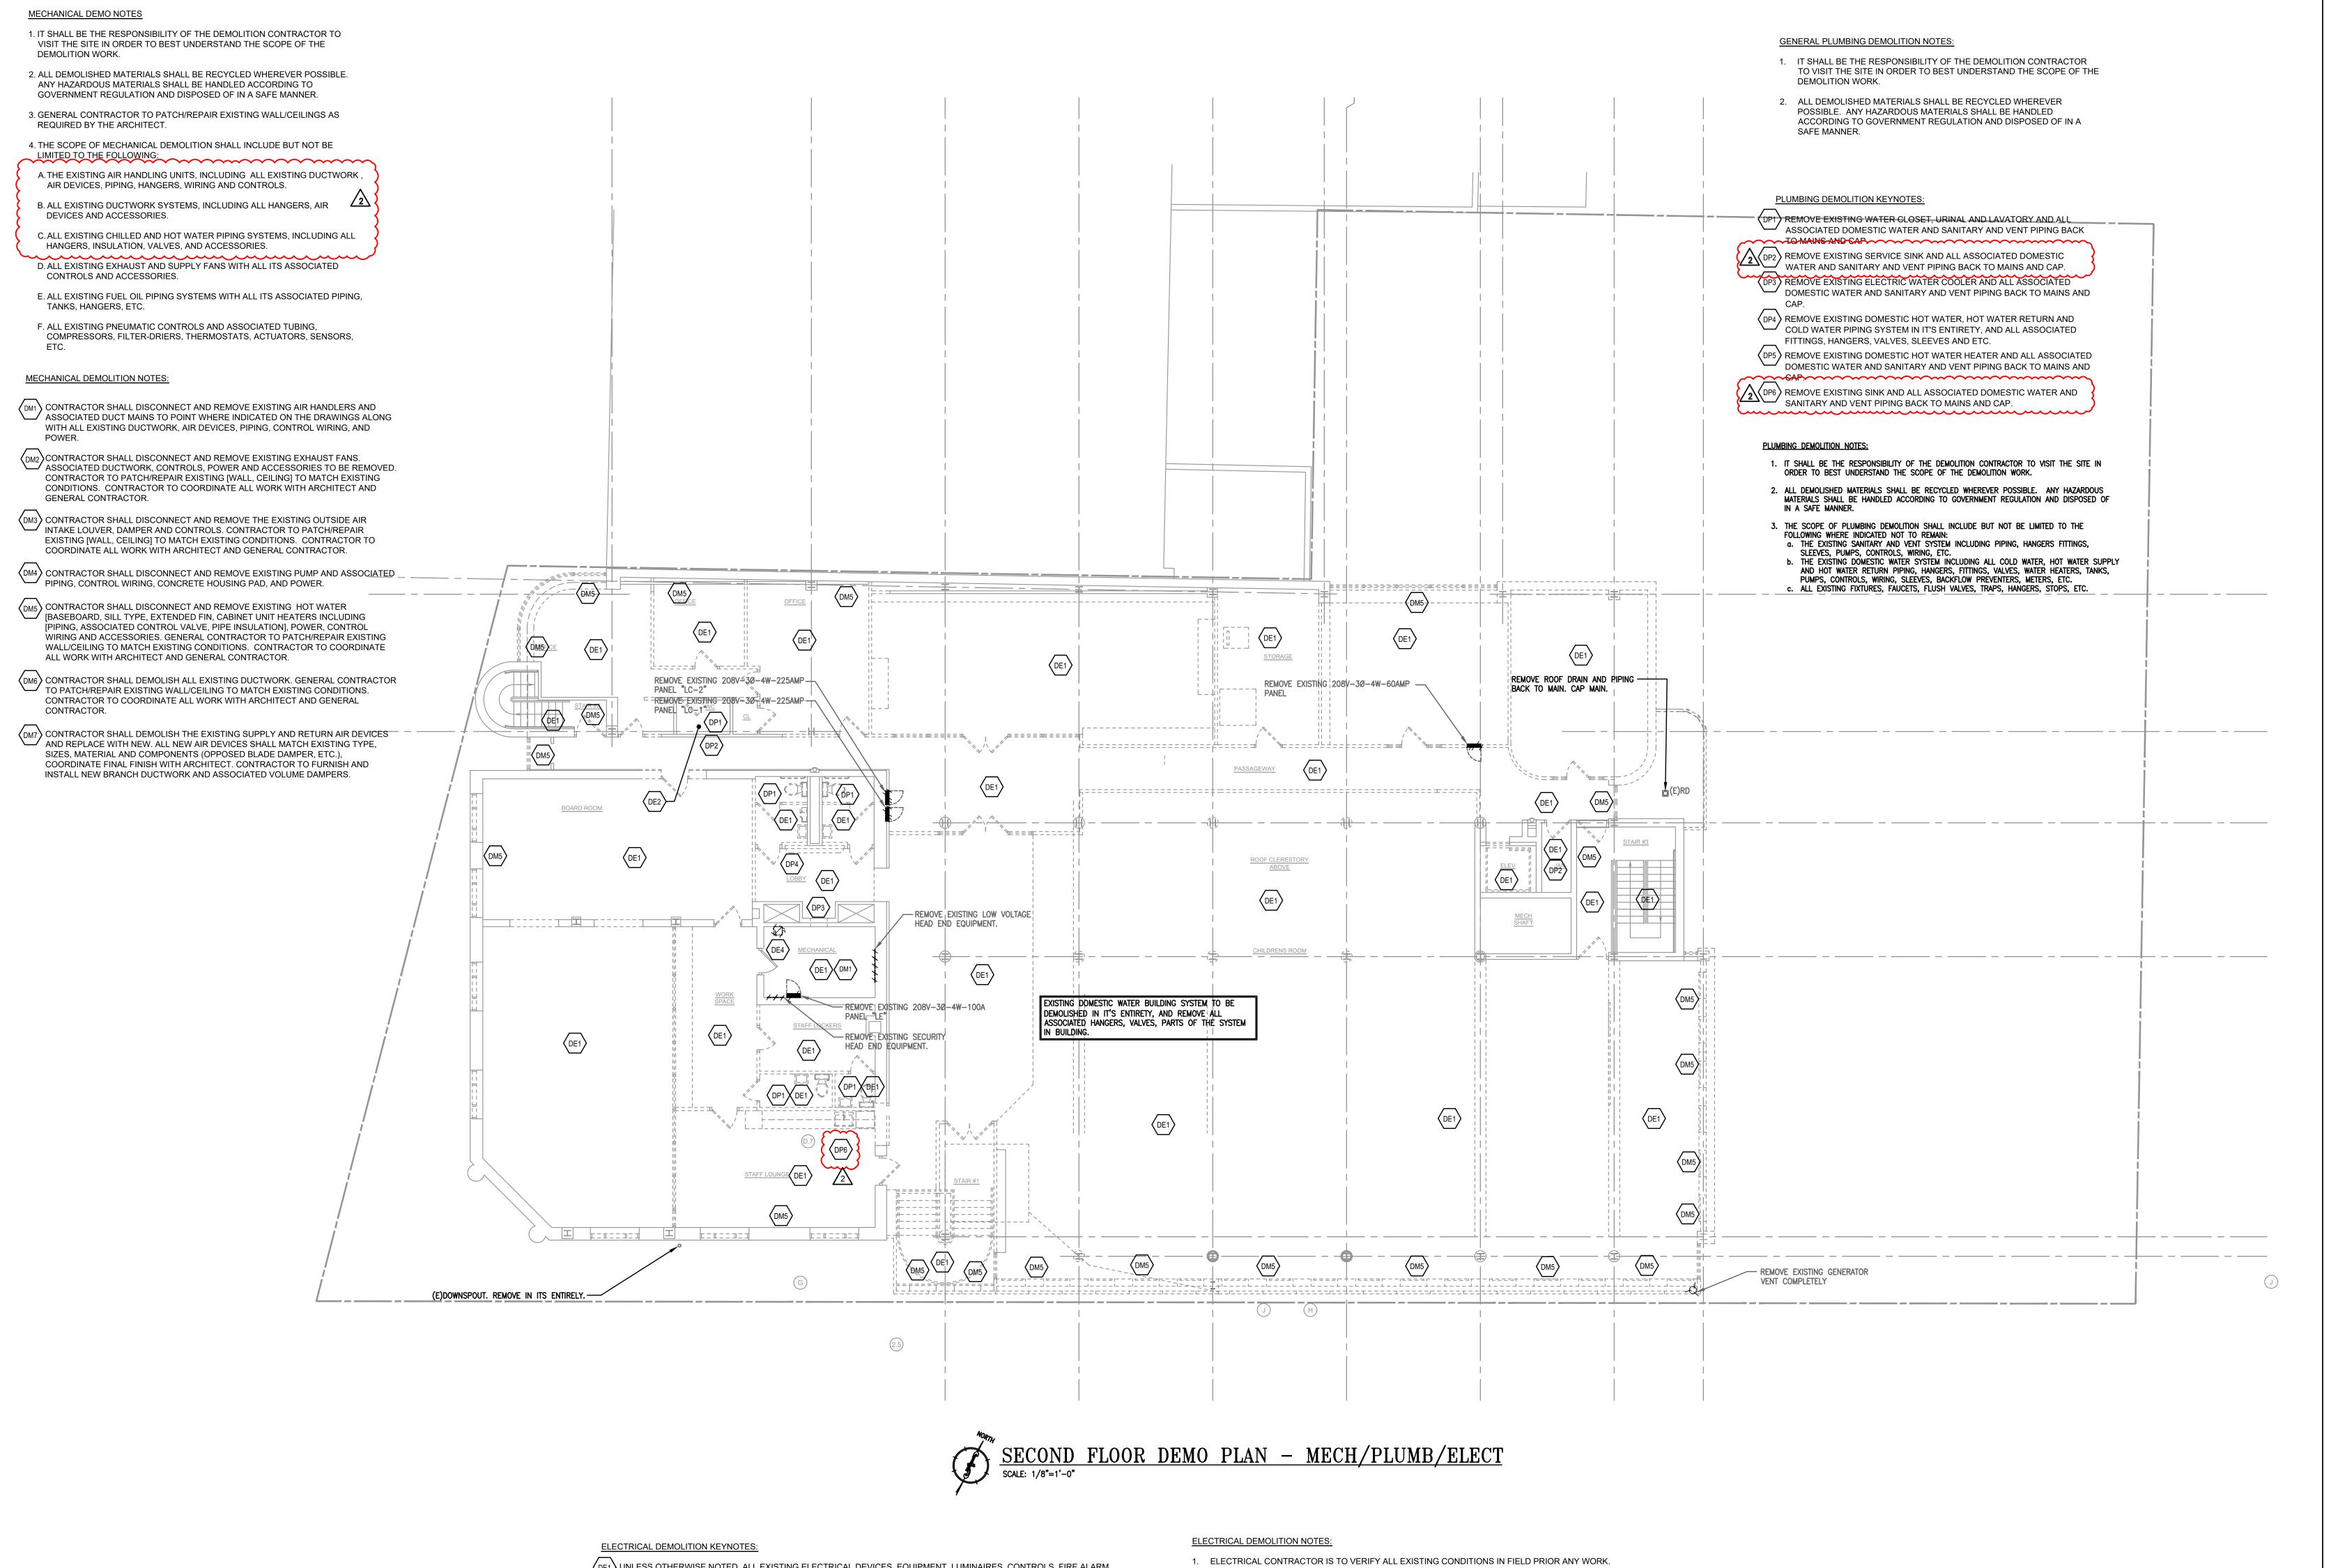
1 09/20/23 2 10/04/23 Addendum 3

Reviewed: Contact: Chris Keenan Project Number: 7010.03-22

Sheet Title: FIRST FLOOR DEMO

Sheet Number:

PLAN - M/P/E



 $\langle_{\text{DE}1}\rangle$ unless otherwise noted, all existing electrical devices, equipment, luminaires, controls, fire alarm DEVICES AND EQUIPMENT, ETC. IN THIS AREA ARE TO BE REMOVED. ALL ASSOCIATED WIRING METHODS ARE TO BE

REMOVED TO THEIR POINT OF ORIGIN.

UNLESS OTHERWISE NOTED, ALL EXISTING ELECTRICAL DEVICES, EQUIPMENT, LUMINAIRES, CONTROLS, FIRE ALARM DEVICES AND EQUIPMENT, ETC. IN THIS AREA ARE TO BE EXISTING TO REMAIN.

 $\langle_{
m DE3}
angle$ INDICATES EXISTING MECHANICAL EQUIPMENT TO REMAIN. UNLESS OTHERWISE NOTED, ALL EXISTING DISCONNECT EQUIPMENT AND WIRING METHODS ARE TO REMAIN.

 $\langle_{\text{DE4}}\rangle$ INDICATES EXISTING DISCONNECTING MEANS ASSOCIATED WITH MECHANICAL EQUIPMENT TO BE REMOVED. REMOVE ALL

REMOVE BRANCH CIRCUIT WIRING METHODS BACK TO POWER SOURCE OR TO ITS NEAREST ACTIVE DEVICE. ALL CIRCUITS SERVING THE EXISTING AREAS THAT ARE INTERRUPTED BY DEMOLITION WORK ARE TO BE RE-ENERGIZED TO MAINTAIN BRANCH CIRCUIT CONTINUITY.

3. TAG ALL OVERCURRENT PROTECTION DEVICES THAT BECOME "SPARE" AS A RESULT OF DEMOLITION WORK. PROVIDE NEW, TYPED PANELBOARD DIRECTORIES FOR ALL DISTRIBUTION AND BRANCH CIRCUIT EQUIPMENT IMPACTED BY THE

4. REMOVE CONDUCTORS AND PROVIDE PULL-STRINGS AND CAP OPENINGS AND CONDUITS THAT ARE NOT TO BE REUSED.

5. ALL POWER SHUTDOWNS ARE TO BE SCHEDULED AND COORDINATED WITH OWNER.

6. IT IS THE INTENT FOR POWER TO REMAIN ACTIVE IN THE EXISTING TO REMAIN AREAS DURING CONSTRUCTION. CONTRACTOR IS TO MODIFY EXISTING WIRING ARRANGEMENT TO COMPLY.

7. IT IS THE INTENT TO REMOVE ALL ELECTRICAL DEVICES WHICH INTERFERE WITH THE NEW CONSTRUCTION WORK OR DEMOLITION WORK WHETHER SPECIFICALLY IDENTIFIED OR NOT.

8. ALL EXISTING INCOMING SERVICE WIRING METHODS, TRANSFORMER, C.T. AND METERING, AND MAIN DISTRIBUTION PANEL EQUIPMENT IS TO REMAIN. EXISTING OVERCURRENT PROTECTION DEVICES ARE TO BE REUSED TO SERVE NEW PANELBOARD EQUIPMENT AS INDICATED ON THE NEW WORK PLANS. PROVIDE NEW FEEDER WIRING METHODS AS

10. COORDINATE ALL DEMOLISHED EQUIPMENT THAT IS TO BE TURNED OVER TO THE OWNER.

THE DELIVERY OF THIS DRAWING SHOULD NOT BE CONSTRUED TO PROVIDE AN EXPRESS WARRANTY OR GUARANTEE TO ANYONE THAT ALL THE DIMENSIONS AND DETAILS ARE EXACT OR TO INDICATE THAT THE USE OF THIS DRAWING IMPLIES THE REVIEW AND APPROVAL BY THE DESIGN PROFESSIONAL OF ANY FUTURE USE. ANY USE OF THIS INFORMATION WITHOUT THE WRITTEN APPROVAL BY THE DESIGN PROFESSIONAL IS AT THE SOLE RISK AND LIABILITY OF THE USER. THE DESIGN PROFESSIONAL RESERVES THE RIGHT TO REMOVE OUR PROFESSIONAL SEAL AND/OR TITLE BLOCK.

NOTICE THE SCHEDULES AND DRAWINGS REPRESENT ONLY CERTAIN REQUIREMENTS OF THE PROJECT. THERE ARE ADDITIONAL REQUIREMENTS IN THE SPECIFICATIONS BOOKLET WHICH THE CONTRACTOR IS BOUND TO PROVIDE. A SUPPLIER OR CONTRACTOR'S PRICING, WHICH IS BASED ONLY ON DRAWINGS OR SCHEDULES, MAY LEAVE IMPORTANT COSTS UNACCOUNTED FOR WHICH WILL ULTIMATELY BE THE CONTRACTOR OR SUPPLIER'S RESPONSIBILITY TO PROVIDE.

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2 10/04/23

Reviewed: Contact: Chris Keenan Project Number: 7010.03-22

Sheet Title: SECOND FLOOR DEMO

Sheet Number:

PLAN - M/P/E



UNLESS OTHERWISE NOTED, ALL EXISTING ELECTRICAL DEVICES, AND EQUIPMENT, ETC. ASSOCIATED WITH DEMOLISHED EQUIPMENT ARE TO BE REMOVED. ALL ASSOCIATED WIRING METHODS ARE TO BE REMOVED TO THEIR POINT OF ORIGIN.

ELECTRICAL DEMOLITION NOTES:

- 1. ELECTRICAL CONTRACTOR IS TO VERIFY ALL EXISTING CONDITIONS IN FIELD PRIOR ANY WORK.
- 2. REMOVE BRANCH CIRCUIT WIRING METHODS BACK TO POWER SOURCE OR TO ITS NEAREST ACTIVE DEVICE. ALL CIRCUITS SERVING THE EXISTING AREAS THAT ARE INTERRUPTED BY DEMOLITION WORK ARE TO BE RE-ENERGIZED TO MAINTAIN BRANCH CIRCUIT CONTINUITY.
- 3. TAG ALL OVERCURRENT PROTECTION DEVICES THAT BECOME "SPARE" AS A RESULT OF DEMOLITION WORK. PROVIDE NEW, TYPED PANELBOARD DIRECTORIES FOR ALL DISTRIBUTION AND BRANCH CIRCUIT EQUIPMENT IMPACTED BY THE
- 4. REMOVE CONDUCTORS AND PROVIDE PULL-STRINGS AND CAP OPENINGS AND CONDUITS THAT ARE NOT TO BE REUSED.
- 5. ALL POWER SHUTDOWNS ARE TO BE SCHEDULED AND COORDINATED WITH OWNER.
- 6. IT IS THE INTENT FOR POWER TO REMAIN ACTIVE IN THE EXISTING TO REMAIN AREAS DURING CONSTRUCTION. CONTRACTOR IS TO MODIFY EXISTING WIRING ARRANGEMENT TO COMPLY.
- 7. IT IS THE INTENT TO REMOVE ALL ELECTRICAL DEVICES WHICH INTERFERE WITH THE NEW CONSTRUCTION WORK OR DEMOLITION WORK WHETHER SPECIFICALLY IDENTIFIED OR NOT.
- 8. COORDINATE ALL DEMOLISHED EQUIPMENT THAT IS TO BE TURNED OVER TO THE OWNER.

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Issued for Permit 1 09/20/23 2 10/04/23 Addendum 3

Reviewed:

Contact: Chris Keenan Project Number: 7010.03-22

Sheet Title: ROOF DEMO PLAN -M/P/E

Sheet Number:

<u>NOTICE</u> THE SCHEDULES AND DRAWINGS REPRESENT ONLY CERTAIN REQUIREMENTS OF THE PROJECT. THERE ARE ADDITIONAL REQUIREMENTS IN THE SPECIFICATIONS BOOKLET WHICH THE THE DELIVERY OF THIS DRAWING SHOULD NOT BE CONSTRUED TO PROVIDE AN EXPRESS WARRANTY OR GUARANTEE TO ANYONE THAT ALL THE DIMENSIONS AND DETAILS ARE EXACT OR TO INDICATE THAT THE USE OF THIS DRAWING CONTRACTOR IS BOUND TO PROVIDE. A SUPPLIER OR IMPLIES THE REVIEW AND APPROVAL BY THE DESIGN PROFESSIONAL OF ANY FUTURE USE. ANY USE OF THIS INFORMATION WITHOUT THE WRITTEN APPROVAL BY THE DESIGN PROFESSIONAL IS AT THE SOLE RISK AND LIABILITY OF THE USER. THE DESIGN PROFESSIONAL RESERVES THE RIGHT TO REMOVE CONTRACTOR'S PRICING, WHICH IS BASED ONLY ON DRAWINGS OR SCHEDULES, MAY LEAVE IMPORTANT COSTS UNACCOUNTED FOR WHICH WILL ULTIMATELY BE THE CONTRACTOR OR SUPPLIER'S RESPONSIBILITY TO PROVIDE. OUR PROFESSIONAL SEAL AND/OR TITLE BLOCK.

MECHANICAL DEMO NOTES

REQUIRED BY THE ARCHITECT.

DEVICES AND ACCESSORIES.

CONTROLS AND ACCESSORIES.

TANKS, HANGERS, ETC.

DEMOLITION WORK.

1. IT SHALL BE THE RESPONSIBILITY OF THE DEMOLITION CONTRACTOR TO VISIT THE SITE IN ORDER TO BEST UNDERSTAND THE SCOPE OF THE

2. ALL DEMOLISHED MATERIALS SHALL BE RECYCLED WHEREVER POSSIBLE. ANY HAZARDOUS MATERIALS SHALL BE HANDLED ACCORDING TO GOVERNMENT REGULATION AND DISPOSED OF IN A SAFE MANNER.

3. GENERAL CONTRACTOR TO PATCH/REPAIR EXISTING WALL/CEILINGS AS

4. THE SCOPE OF MECHANICAL DEMOLITION SHALL INCLUDE BUT NOT BE

AIR DEVICES, PIPING, HANGERS, WIRING AND CONTROLS.

HANGERS, INSULATION, VALVES, AND ACCESSORIES.

LIMITED TO THE FOLLOWING: A. THE EXISTING AIR HANDLING UNITS, INCLUDING ALL EXISTING DUCTWORK,

B. ALL EXISTING DUCTWORK SYSTEMS, INCLUDING ALL HANGERS, AIR $\frac{2}{2}$


C. ALL EXISTING CHILLED AND HOT WATER PIPING SYSTEMS, INCLUDING ALL

E. ALL EXISTING FUEL OIL PIPING SYSTEMS WITH ALL ITS ASSOCIATED PIPING,

COMPRESSORS, FILTER-DRIERS, THERMOSTATS, ACTUATORS, SENSORS,

D. ALL EXISTING EXHAUST AND SUPPLY FANS WITH ALL ITS ASSOCIATED

F. ALL EXISTING PNEUMATIC CONTROLS AND ASSOCIATED TUBING,

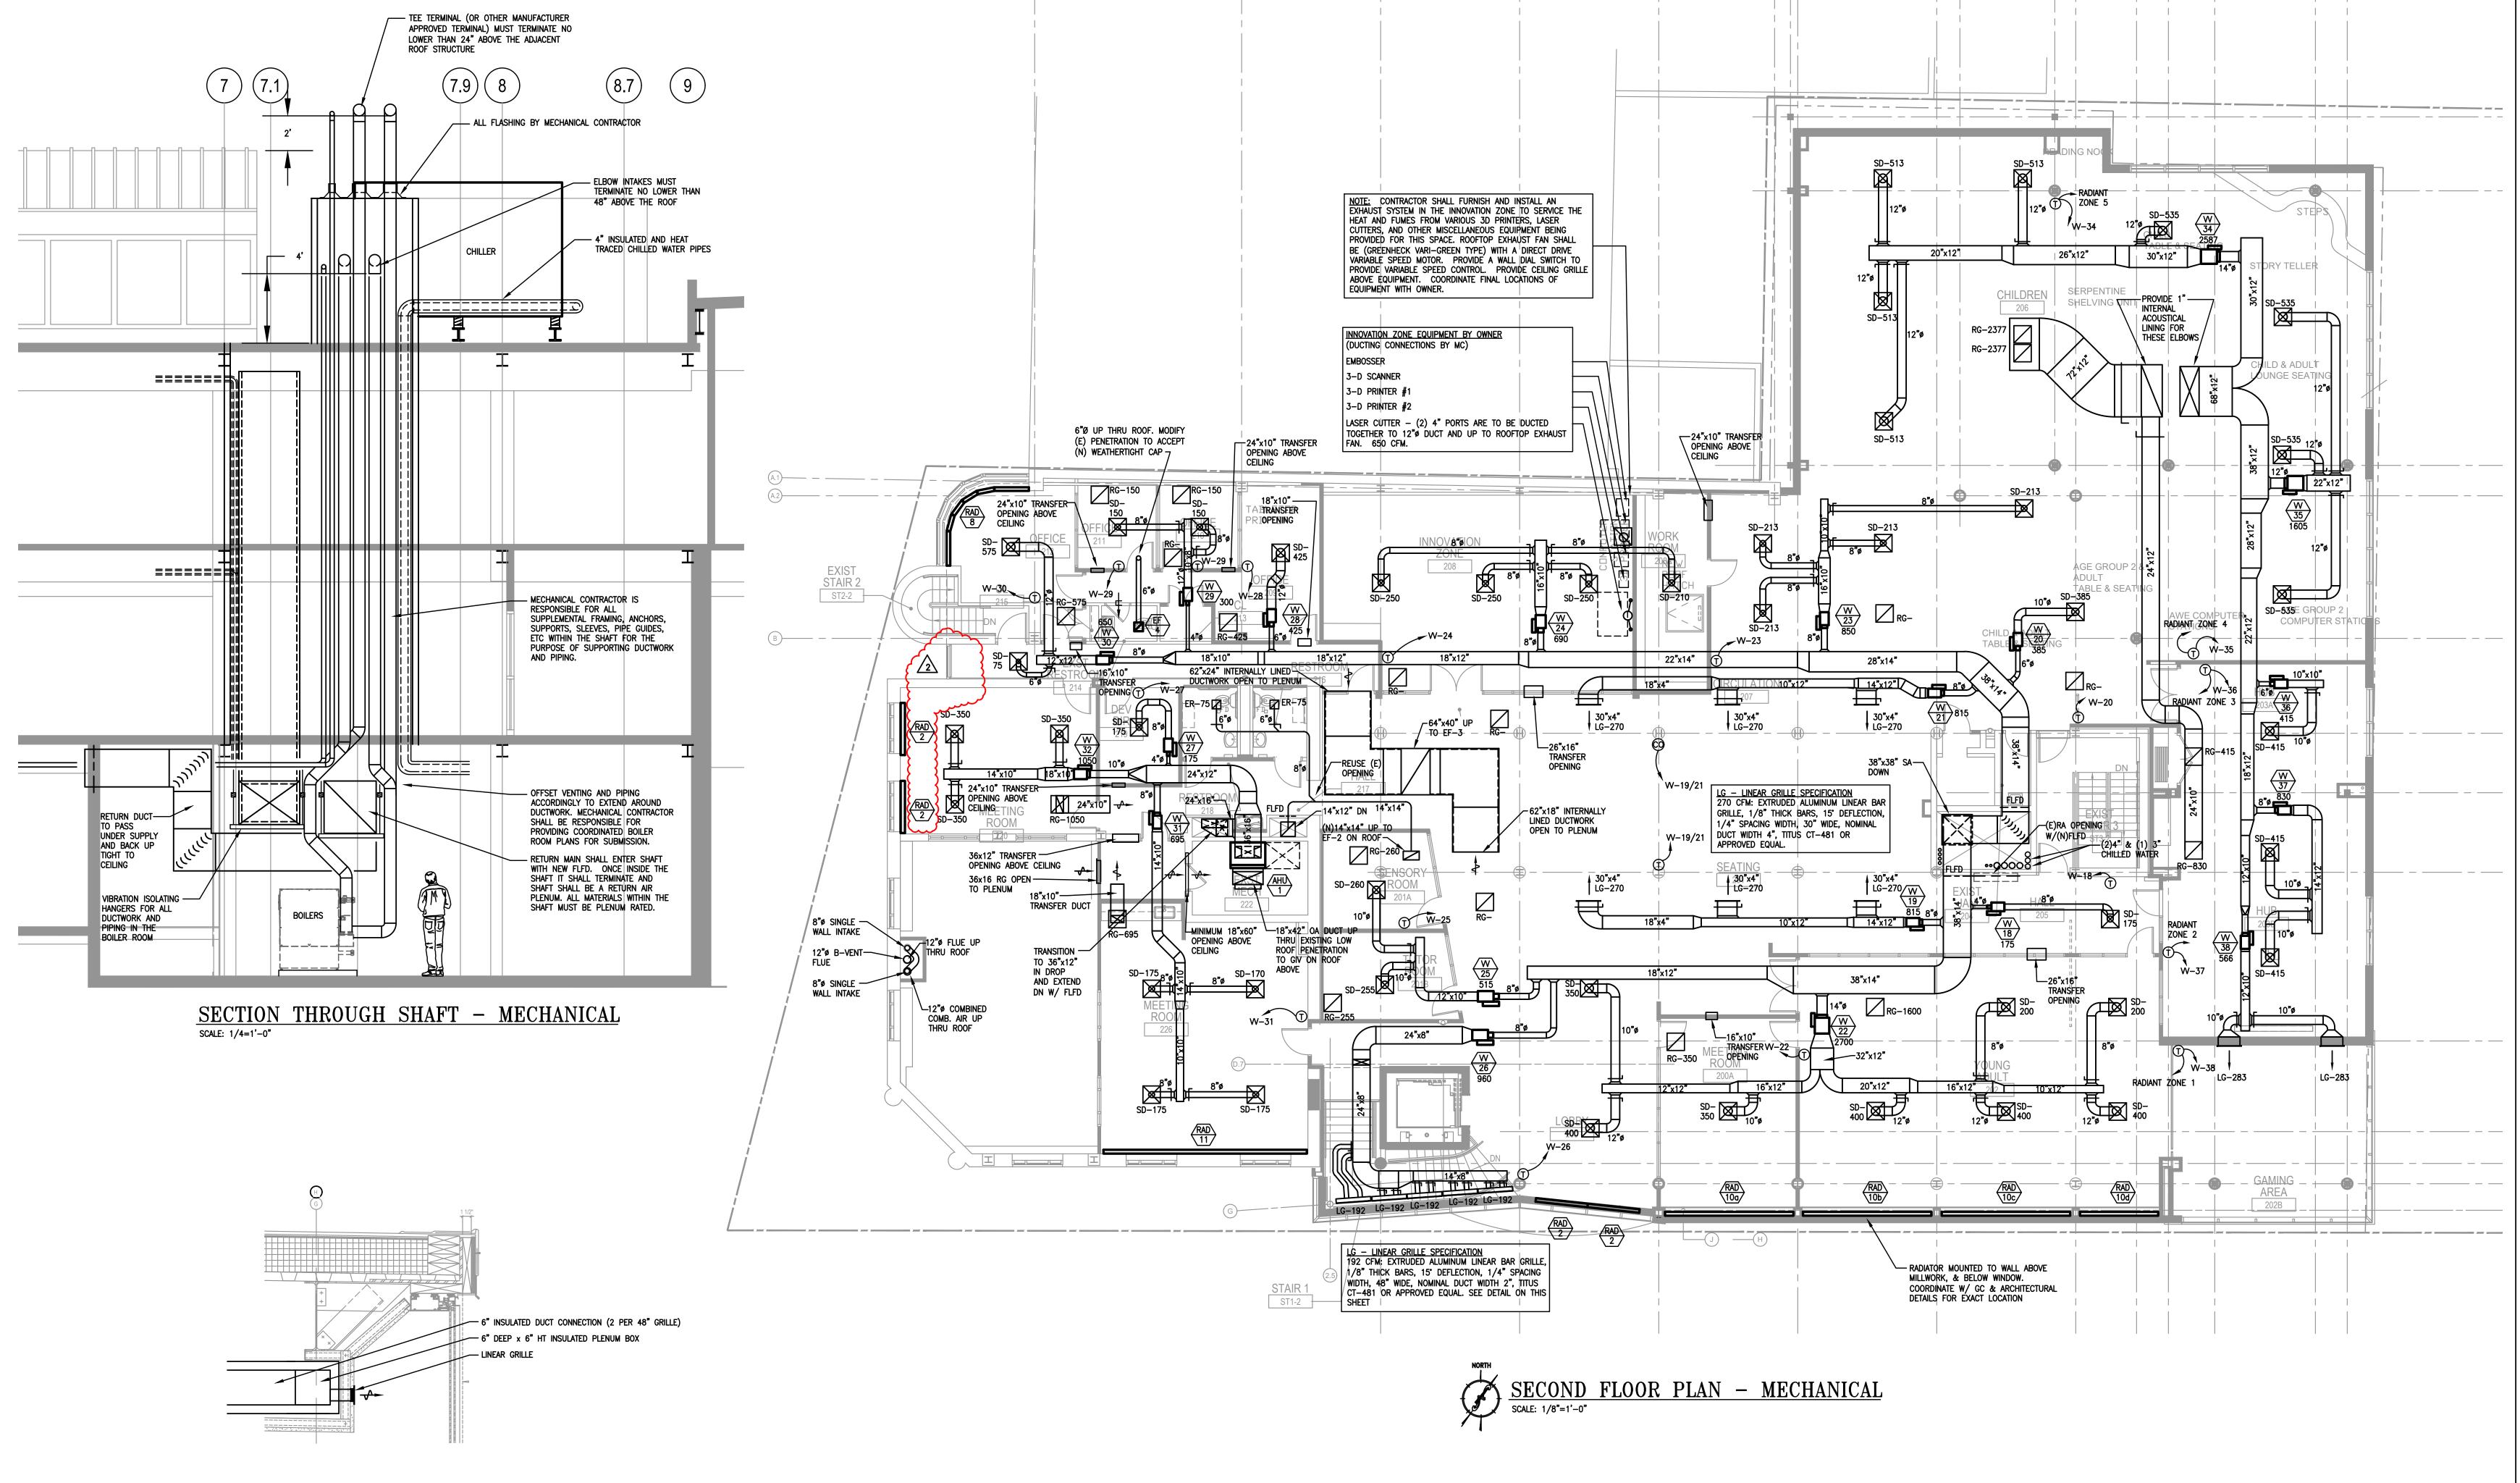

SECTION AT LOBBY GRILLES- MECHANICAL

THE DELIVERY OF THIS DRAWING SHOULD NOT BE CONSTRUED TO PROVIDE AN EXPRESS WARRANTY OR GUARANTEE TO ANYONE THAT ALL THE DIMENSIONS AND DETAILS ARE EXACT OR TO INDICATE THAT THE USE OF THIS DRAWING IMPLIES THE REVIEW AND APPROVAL BY THE DESIGN PROFESSIONAL OF ANY FUTURE USE. ANY USE OF THIS INFORMATION WITHOUT THE WRITTEN APPROVAL BY THE DESIGN PROFESSIONAL IS AT THE SOLE RISK AND LIABILITY OF THE USER. THE DESIGN PROFESSIONAL RESERVES THE RIGHT TO REMOVE OUR PROFESSIONAL SEAL AND/OR TITLE BLOCK.

NOTICE THE SCHEDULES AND DRAWINGS REPRESENT ONLY CERTAIN REQUIREMENTS OF THE PROJECT. THERE ARE ADDITIONAL REQUIREMENTS IN THE SPECIFICATIONS BOOKLET WHICH THE CONTRACTOR IS BOUND TO PROVIDE. A SUPPLIER OR CONTRACTOR'S PRICING, WHICH IS BASED ONLY ON DRAWINGS OR SCHEDULES, MAY LEAVE IMPORTANT COSTS UNACCOUNTED FOR WHICH WILL ULTIMATELY BE THE CONTRACTOR OR SUPPLIER'S RESPONSIBILITY TO PROVIDE.

ARCHITECTURE INTERIOR DESIGN LANDSCAPE ARCHITECTURE

123 Justison Street, Suite 101 Wilmington, Delaware 19801 p. 302 622 9550

www.bernardon.com

136 Poplar Street, Ambler, PA 19002 1950 Route 70, Suite 102, Cherry Hill, NJ 08003 www.mchugheng.com 215.641.1158

HAVERFORD TOWNSHIP FREE LIBRARY 1601 Darby Road **Haverford Township** Havertown, PA 19083

Owner:

HAVERFORD TOWNSHIP FREE LIBRARY 1601 Darby Road **Haverford Township** Havertown, PA 19083

2 10/04/23 Addendum 3

Reviewed: Contact: Chris Keenan

Project Number: 7010.03-22

Sheet Title: SECOND FLOOR PLAN -MECHANICAL

Sheet Number:

DUCTWORK

Co	ONTROL	VALVE SCHEDUL	E	CV 1-11
NO.	SERVICE	TYPE	GPM	REMARKS
1 & 6	HW RAD.	2-WAY MODULATING	1.0	①
2	HW RAD.	2-WAY MODULATING	2.2	①
3	HW RAD.	2-WAY MODULATING	3.0	①
5	HW RAD.	2-WAY MODULATING	0.8	①
7	HW RAD.	2-WAY MODULATING	1.4	①
4	HW RAD.	2-WAY MODULATING	0.6	①
9	HW RAD.	2-WAY MODULATING	1.7	①
11	HW RAD.	2-WAY MODULATING	3.6	①
8	AHU	2-WAY MODULATING	5.0	INTEGRATE INTO AHU CONTROLS
10	CUH	2-WAY MODULATING	4.0	2
12	HW RAD.	2-WAY MODULATING	1.5	①
13	HW RAD.	2-WAY MODULATING	1.2	①

1 INTEGRATE CONTROL VALVE WITH ASSOICATED VAV CONTROLLER 2 WALL MOUNTED THERMOSTAT WITH +/- 3 DEGREE ADJUSTMENT

					F	RADI	ATOF	R SCH	EDU	LE	RAD 1-10	
NO	QTY	TYPE	DTU /UD /I E	DTU /UD	GPM	D	IMENSI	ONS	WA	TER	BASIS OF	DEMADIC
NO	QIT	TYPE	BTU/HR/LF	BTU/HR	EACH	L	W	Н	IN	OUT	DESIGN	REMARKS
1	1	WALL MOUNTED	940	16920	1.7	18'	2"	17-1/4"	160	140	RUNTAL RF-6	1235678
2	4	FLOOR MOUNTED	1100	6600	0.7	6'	2"	17-1/4"	160	140	RUNTAL RF-6	12356789
3	0	NOT USED										
4	1	WALL MOUNTED	2022	5055	0.6	2.5'	5 "	17-1/4"	160	140	RUNTAL R3F-6	1345678
5	14	BARE ELEMENT	720	2160	.2	3'	4"	4"	160	140	STERLING VERSA—LINE STYLE "B" BARE ELEMENT	345678
6	0	NOT USED										
7	1	WALL MOUNTED	570	7980	0.8	12'	5 "	11-1/4"	160	140	STERLING DURA-VANE II JDVP31 PEDESTAL MOUNT	4567810
8	1	FLOOR MOUNTED	570	9120	1.0	16'	5 "	11-1/4"	160	140	STERLING DURA-VANE II JDVP31 PEDESTAL MOUNT	456781
9a	1	WALL MOUNTED	625	24375	2.5	39'	2"	11-1/2"	160	140	RUNTAL RF-3	1345678
9b	1	WALL MOUNTED	625	4687	0.5	7.5'	2"	11-1/2"	160	140	RUNTAL RF-3	1345678
10a,b,c	3	WALL MOUNTED	625	8750	1.0	14'	2"	11-1/2"	160	140	RUNTAL RF-3	123567812
10d	1	WALL MOUNTED	625	5625	0.6	9,	2"	11-1/2"	160	140	RUNTAL RF-3	123567812
11	1	WALL MOUNTED	625	14375	1.5	23'	2"	11-1/2"	160	140	RUNTAL RF-3	123567812

RETURN. PIPING SHALL BE COMPLETELY CONCEALED (5) REFER TO CONTROL VALVE

PIPING SHALL BE COMPLETELY CONCEALED

INFORMATION

SCHEDULE FOR ADDITIONAL 9 PROVIDE VERTICAL PIPE TRIM FROM FINISHED FLOOR TO END CAP TRIM.

INSTALLTION REQUIREMENTS CONCEALED UNITS SHALL BE MFG STD GREY BROWN COLOR 8019 PROVIDE RADIUSED ENCLOSURE. DESIGN

CHASING EXISTING EXTERIOR WALL 6 FINISH BY ARCHITECT FROM STD COLORS. 7 SUPPLY & RETURN BALL VALVES 8 MANUFACTURERS: RUNTAL, PROVIDE MITERED CORNERS IN ORDER TO PROVIDE MITERED CORNERS IN ORDER TO ORDER TO PROVIDE RADIUSED INTENT: (3) 2FT SECTIONS, (2) 4FT SECTIONS, & 4 MITERED CORNERS

ORDER TO PROVIDE RADIUSED ENCLOSURE. DESIGN INTENT: (4) 2FT SECTIONS, (2) 4FT SECTIONS, & 5 MITERED CORNERS

FACTORY PROVIDED 12" FULL END CLIPS, WALL BRACKETS, AND OFFSET BOLTS REQUIRED FOR MANUFACTURER'S WITH MASONRY CONTRACTOR

PROVIDE ALL FACTORY PROVIDED PEDESTAL COORDINATE RIGHTHAND, LEFTHAND, 4 BRACKETS REQUIRED FOR MANUFACTURER'S WITH MASONRY CONTRACTOR INSTALLATION REQUIREMENTS. BRACKETS SHAPE OF THE PROVIDE ALL FACTORY PROVIDED PEDESTAL SHAPE OF THE PROVIDE INSTALLATION REQUIREMENTS. BRACKETS SHALL BE FACTORY FINISHED TO MATCH RADIATOR. VULCAN, STERLING OR PRIOR 12 MOUNT UNIT ON WALL ABOVE MILLWORK, AND BELOW WINDOW. PROVIDE CONNECTORS, TRIM PIECES, AND HARDWARE REQUIRED TO CONCEAL ALL PIPING.

					EXHA	AUST I	FAN S	CHEDU	JLE (I	EF)			
Tag	Serves	Configuration	CFM	External Static (in.)	Fan HP	RPM	Sones	Inlet dBA	Volts	Phase	Control	Basis of Design	Comments
1	MECHANICAL ROOM	SIDEWALL PROPELLER	950	0.25	1	1282	11.4	63	120	1	THERMOSTAT & REFRIGERANT MONITORING STATION	GREENHECK SE1-20-420-VG	1, 2, 5, 6
2	RESTROOMS	CENTRIFUGAL DOWNBLAST	1300	0.5	1/3	1009	7.5	55	208	3	BAS - TIMECLOCK	GREENHECK GB-141	1, 2, 4, 5
3	BUILDING RELIEF	ROOF MOUNTED FABRA HOOD	19400	0.50	5	290	14.2	64	208	3	BUILDING DIFFERENTIAL PRESSURE SENSOR	GREENHECK LB-54-50	1, 2, 3, 5
4	OFFICE RESTROOM	CEILING MOUNTED	100	0.20	23 Watts	290	0.3	-	120	1	BAS - TIMECLOCK	GREENHECK SP-110-VG	2, 4, 5
5	LASER CUTTER	CENTRIFUGAL DOWNBLAST	650	0.50	1/6	1577	9.4	58	120	1	DRY CONTACT INTERLOCK WITH LASER CUTTER	GREENHECK G-095-VG	1, 2
6	INNOVATION ZONE	CENTRIFUGAL DOWNBLAST	400	0.50	1/10	1474	6.8	53	120	1	WALL MOUNTED DIAL SPEED CONTROL SWITCH	GREENHECK G-090-VG	1, 2

Motor operated damper with end switch to prove damper operation. Interlock with fan via BAS. Provide BAS alarm

Equal by Acme, Penn Vent, Fantech, Cook

Sequence: Start-up - Upon a rise in space pressure above space pressure setpoint (0.05" wg, adjustable) as sensed by differential pressure sensor; motor operated damper shall open, then fan shall enable. Pressure Control -Fan shall modulate to maintain space pressure setpoint (0.05" wg, adjustable). Shut-down - Upon a fall in space pressure below space pressure setpoint (0.05" wg, adjustable) as sensed by differential pressure sensor, fan shall disable, then motor operated damper shall close

Sequence: Start-up - Fan shall enable during occupied hours (06:00 - 21:00, adjustable) as scheduled by BAS. Shut-down - Fan shall disable during unoccupied hours (21:00 - 06:00, adjustable) as scheduled by BAS

Fan motor with current transducer to prove motor operation. Provide BAS alarm

6 Sequence: Start-up - Upon a rise in space temperature above the space temperature setpoint (80°F, adjustable) as sensed by reverse acting thermostat fan shall enable. Shut-down - Upon a fall in space temperature below the space temperature setpoint (80°F, adjustable) as sensed by reverse acting thermostat fan shall disable. Refrigerant Monitoring Mode - Upon recieving a signal from the RMS, the fan shall enable.

		U	NIT H	EATE	R SCHE	DULE	(CUH/	UH)		
Tag	Туре	KW	МВН	GPM	Size L x W x H	Voltage / Phase	Amps	МОСР	Basis of Design	Commen
CUH-1	FAN-FORCED RECESSED WALL HEATER	4.8	16.4	-	16 x 4 x 20	208 / 1	23.1	30	QMARK SSAR4808	1, 2, 3, 6,
CUH-2	FAN-FORCED RECESSED WALL HEATER	-	40	4	47 x 9 x 25	120 / 1	0.65	20	STERLING RW-04	3, 8, 9
CUH-3	FAN-FORCED RECESSED CEILING HEATER	4	13.6	-	24 x 24 x 7	208 / 1	19.2	25	QMARK CDF548	3, 4
CUH-4	FAN-FORCED RECESSED CEILING HEATER	-	40	4	47 x 9 x 25	120 / 1	0.65	20	STERLING RC 04	3, 8, 9, 10
UH-1	CEILING HUNG VERTICAL UNIT HEATER	-	44	7.5	19 x 8.5 x 22	120/1	2.2	15	STERLING HS 108	1, 7
UH-2	CEILING HUNG VERTICAL UNIT HEATER	-	8.3	1.3	19 x 8.5 x 22	120/1	0.8	15	STERLING HS 18	1, 7

1 Provide proportional heating element and fan control

2 Provide digital touchscreen thermostat with 5/2 programmability, 4 periods per day, lockout control, and dry contact connection to BAS

3 Finish selected by architect from standard colors 4 Integral thermostat

5 Provide 2-stage heating element and thermostat

6 Provide fully recessed mounting of backbox in order to provide flush mounting of grille. Coordinate with masonry contractor and electrical contractor in order to provide flush mounting of grille and fully recessed mounting of backbox in masonry walls.

7 Provide manufacture provided integration option in order to integrate with BAS for ENABLE/DISABLE based on OA temperature

8 Provide 3-speed ECM motor, 3-way hot water control valve, wall mounted digital thermostat. Integrate into BAS. 9 Provide high capacity 2-row heating coil

10 Provide flush face, supply duct collar, and return duct collar

	3	В	Вох
1)1		
2)2		1
3)3		1
4)4		
5)5		1
5/	6A		
	6B		1

SENSORLESS CLOSE COUPLED **CHILLED WATER** 2521 208/3 *1234568 Armstrong VERTICAL INLINE TANGO PUMP SENSORLESS CLOSE COUPLED **CHILLED WATER** 2521 208/3 Armstrong *1234568 VERTICAL INLINE TANGO PUMP SENSORLESS CLOSE COUPLED **HOT WATER** 2826 123478 Armstrong VERTICAL INLINE TANGO PUMP SENSORLESS CLOSE COUPLED **HOT WATER** 2826 123478 Armstrong VERTICAL INLINE TANGO PUMP SENSORLESS CLOSE COUPLED RADIANT FLOOR 2383 208/3 2 3 4 8 Armstrong VERTICAL INLINE TANGO PUMP SENSORLESS CLOSE COUPLED Armstrong 2 3 4 8 VERTICAL INLINE TANGO PUMP

PUMP SCHEDULE (P)

FT. HD. RPM HP Voltage / Phas

Manufacturer

Model

*Provide algorithmic controls to maintiain 120 gpm minimum flow for proper operation of new chiller Comments

Configuration

1 Vibration isolators

2 Flexible connections 3 Pressure gauge discharge/suction

4 Inlet strainer

5 Provide air/dirt separator equal to SPIROTHERM VDT400 6 Provide ASME expansion tank equal to ARMSTRONG AX-60V

7 Provide air/dirt and hydraulic separator equal to SPIROTHERM VDX300

8 Provide Factory Furnished Fused Disconnect accessory

AIR COOLED CHILLER SPECIFICATION • 90 TONS, HIGH EFFICIENCY, AIR COOLED CHILLER WITH "SUPER QUIET" FACTORY SOUND PACKAGE

10.21 EER, 15.98 EER (IPLV.IP)
208V, 3PH, 60HZ, 395 MCA, 500 MOCP

• (4) COMPRESSORS, (2) CIRCUITS, (4) CAPACITY STEPS BASIS OF DESIGN TRANE CGAM (SUBSTITUTIONS REQUIRE ACOUSTICAL AND WEIGHT ANALYSIS AND ENGINEER APPROVAL)
210 GPM, 54'F EWT, 44'F LWT, 117 GPM MIN FLOW, 8.11FT HD MAX WATER PD
FREEZE PROTECTION, HIGH AMBIENT CAPABILITY

 PROVIDE VIBRATION ISOLATION SPRINGS ON DUNNAGE PROVIDED UNDER STRUCTURAL CONTRACT OCTAVE BAND SOUND PRESSURE (DB), 'A' WEIGHTED

AHRI LOAD FACTOR (%) 63 HZ 125 HZ 250 HZ 500 HZ 1000 HZ 2000 HZ 4000 HZ 8000 HZ OVERALL SOUND PRESSURE LEVEL, LP. DBA @ 1 M (3.3 FT)

RTU ROOFTOP UNIT SPECIFICATION

15 TON PACKAGED VARIABLE AIR VOLUME (VAV) ROOFTOP GAS/ELECTRIC, DOWNFLOW

11.00 EER, 12.20 IEER
208V, 3PH, 60HZ, 68 MCA, 90 MOCP • (2) COMPRESSOR CIRCUITS,

 BASIS OF DESIGN TRANE YSD (SUBSTITUTIONS REQUIRE ACOUSTICAL AND WEIGHT ANALYSIS AND ENGINEER APPROVAL) • GAS HEAT: 350 MBH INPUT (250 MBH 1ST STAGE), 280 MBH OUTPUT (200 MBH 1ST STAGE), 70°F EAT, 113°F LAT

184 MBH TOTAL, 149 MBH SENSIBLE2,800 LBS WEIGHT PROVIDE VIBRATION ISOLATION ROOF CURB

ACOUSTICS

						VA	V BC	X SC	HED	ULE ((VV)				
		May	Min	DCV M	lin CFM	Inlat	Outlet			Heati	ng Coil			Control	
Tag	Box Size	Max CFM	CFM	CO2	occ*	Inlet Size	Outlet Size	EAT (°F)	LAT (°F)	МВН	GPM	HD LOSS (FT)	EWT(°F)	Control Valve	Basis of Design
VV-01	8	570	171	-	-	8	12x10	55	106	10	1.0	0.8	160	2-WAY	ENVIRO-TEC SDR
VV-02	12	1800	540	0	-	12	16x15	55	95	25	2.5	0.8	160	2-WAY	ENVIRO-TEC SDR
VV-03	12	1435	431	0	-	12	16x15	55	95	20	2.0	0.5	160	2-WAY	ENVIRO-TEC SDR
VV-04	8	735	221	-	-	8	12x10	55	98	11	1.1	0.6	160	2-WAY	ENVIRO-TEC SDR
VV-05	10	895	269	-	-	10	14x12	55	97	13	1.3	0.8	160	2-WAY	ENVIRO-TEC SDR
VV-06A	8	660	198	-	-	8	12×10	55	99	10	1.0	0.6	160	2-WAY	ENVIRO-TEC SDR
VV-06B	10	1020	306	-	-	10	14x12	55	95	14	1.4	0.8	160	3-WAY	ENVIRO-TEC SDR
VV-07	4	225	68	-	0	4	12x8	55	94	10	1.0	0.5	160	2-WAY	ENVIRO-TEC SDR
VV-08A	8	595	180	-	-	8	12x10	55	103	10	1.0	0.6	160	2-WAY	ENVIRO-TEC SDR
VV-08B	8	595	180	-	-	8	12×10	55	103	10	1.0	0.6	160	2-WAY	ENVIRO-TEC SDR
VV-08C	8	595	180	-	-	8	12×10	55	103	10	1.0	0.6	160	2-WAY	ENVIRO-TEC SDR
VV-09	8	865	260	-	-	8	12x10	55	95	12	1.2	0.6	160	2-WAY	ENVIRO-TEC SDR
VV-10	8	900	270	-	-	8	12x10	55	95	41	4.1	4.2	160	2-WAY	ENVIRO-TEC SDR
VV-11	4	250	75	-	0	4	12x8	55	97	12	1.2	0.5	160	2-WAY	ENVIRO-TEC SDR
VV-12	4	225	68	_	0	4	12x8	55	94	10	1.0	0.5	160	2-WAY	ENVIRO-TEC SDR
VV-13	8	675	203	_	-	8	12x10	55	98	10	1.0	0.6	160	2-WAY	ENVIRO-TEC SDR
VV-14	6	450	135	_	-	6	12x8	55	119	10	1.0	0.5	160	3-WAY	ENVIRO-TEC SDR
VV-15	4	200	60	_	0	4	12x8	55	98	10	1.0	0.5	160	2-WAY	ENVIRO-TEC SDR
VV-16	8	630	189	_	_	8	12x10	5 5	101	10	1.0	0.6	160	2-WAY	ENVIRO-TEC SDR
VV-17	12	1960	588	_	_	12	16x15	55	99	30	3.0	1.6	160	3-WAY	ENVIRO-TEC SDR
VV-18	4	200	60	_	0	4	12x8	55	98	10	1.0	0.5	160	2-WAY	ENVIRO-TEC SDR
VV-19	8	815	245	0	-	8	12x10	55	94	11	1.1	0.8	160	2-WAY	ENVIRO-TEC SDR
VV-20	6	385	116	_	0	6	12x8	55	96	18	1.8	0.7	160	2-WAY	ENVIRO-TEC SDR
VV-21	8	815	245	0	_	8	12x10	5 5	94	11	1.1	0.8	160	2-WAY	ENVIRO-TEC SDR
VV-22	14	2700	810	_	-	14	20x18	55	96	38	3.8	2.1	160	2-WAY	ENVIRO-TEC SDR
VV-23	8	850	255	_	0	8	12×10	55	96	12	1.2	0.6	160	2-WAY	ENVIRO-TEC SDR
VV-24	6	465	140	_	0	6	12x8	55	117	10	1.0	0.5	160	2-WAY	ENVIRO-TEC SDR
VV-25	8	515	155	_	_	8	12×10	55	111	10	1.0	0.6	160	2-WAY	ENVIRO-TEC SDR
VV-26	8	960	288	_	_	8	12×10	55	9 5	44	4.4	1.5	160	2-WAY	ENVIRO-TEC SDR
VV-27	4	225	67.5	_	0	4	12x8	55	94	10	1.0	0.5	160	2-WAY	ENVIRO-TEC SDR
VV-28	6	475	143	-	-	6	12x8	55	116	10	1.0	0.5	160	2-WAY	ENVIRO-TEC SDR
VV-29	4	300	90	_	-	4	12x8	55	98	15	1.5	0.5	160	2-WAY	ENVIRO-TEC SDR
VV-30	8	650	195	_	0	8	12x10	55	100	10	1.0	0.6	160	3-WAY	ENVIRO-TEC SDR
VV-31	8	695	210	_	_	8	12x10	55	96	10	1.0	0.6	160	2-WAY	ENVIRO-TEC SDR
VV-33	6	450	1 35	_	0	6	12x8	55	119	10	1.0	0.5	160	2-WAY	ENVIRO-TEC SDR
VV-34	14	2587	776	_	_	14	20x18	55	97	38	3.8	2.1	160	2-WAY	ENVIRO-TEC SDR
VV-35	12	1605	482	_	-	12	16x15	55	109	30	3.0	1.6	160	3-WAY	ENVIRO-TEC SDR
VV-36	6	415	125	_	0	6	12x8	55	125	10	1.0	0.5	160	2-WAY	ENVIRO-TEC SDR
VV-37	8	830	249	_	_	8	12x10	55	97	12	1.2	0.6	160	2-WAY	ENVIRO-TEC SDR
VV-38	8	566	170	_	_	8	12x10	55	106	10	1.0	0.6	160	2-WAY	ENVIRO-TEC SDR
VV-32	10	1050	315	0	_	10	14×12	55	96	15	1.5	0.3	160	3-WAY	ENVIRO-TEC SDR

* Integrate room occupancy sensor(s) into VAV controller in order to provide occupancy based demand controlled ventilation of space. Design intent is that occupancy sensors shall be provided with integral 24V output. Coordinate with electrician to ensure output is provided. Provide all accessories required to integrate occupancy sensor into VAV controller in order to provide occupancy based demand controlled ventilation of space including but not limited to wiring, relays, transformers, junction boxes, conduit, fittings, etc.

																					AIR	HA	NDL	ING	UNI	r sc	HED	ULE	E																		
	Unit								Suppl	y Fan												Ch	illed Wa	ter Coil									Hot V	Vater Coil							Filt	er			Basis	of Design	
							Fa	n							Motor		T-4		-:1-1-											Takal						0.0			Pre-	Filter		Fi	inal Filter				
Tag	Туре	Туре	Qty C	Class	_	Heatin Airflov (CFM)	v Airf	low RP	м внр	E.S.I (inH2	P. T.9	l Di	rive Vo	oltage	ower (HP)	M Contr	Capac	al Ser city Cap hr) (Bt	acity	°F	°F	LAT-DB °F	LAT-WB °F	F.V. (ft/min)	A.P.D. (inH2O)	°F	WT Flow °F (G		W.P.D. ftH2O)	Total Capacity (Btu/br)	°F	AT-DB °F (F.V. ft/min)	A.P.D. E	WT LW	Flow F	Rate W.P	.D. 20) Ty	pe De	epth Effi	ciency	Туре	Depth I	Efficiency	Mfg	Model	Comments
AHU-1	VERTICAL CENTRAL STATION VAV	FORWARD CURVED	1	1	4800	4800	76		02 5.7	1.0) 2.	75 B	elt 2	08/3	7.5 17	50 VFC	1693	48 12	1211	80	67	56.9	55.7	493	0.39	45	55	50	12.7	90000	62.3	79.7	511	0.21 1	140	9	5.	6		-	-	Pleated (MERV 14)	4	90	Daikin	Destiny	1, 2, 3, 4, 5, 6,
AHU-2	HORIZONTAL CENTRAL STATION VAV	PLENUM	1	2	19400	19400	41	00 144	47 25.9	3.0	6.	05 B	elt 20	08/3	30 17	50 VFD	5816	00 39	5488	80	67	54.3	53.7	491	0.72	45	55 1	50	9.9	400000	60.2	79.3	511	0.21 1	140	40	8.	6 KMER		2	30	Varicel SH cartridge	12	95	Daikin	Vision	6, 7

Mixing Box

Bottom Filter Access 3 Belt Tensioner

4 Hinged Access Panels

5 Provide Airflow Measuring Station 6 Vibration isolating spring mounts

7 Extend condensate to nearby indirect waste drain

			DUCTI	LESS SP	PLIT SYS	STEM S	CHEDU	ILE (CU	/ACU)					
Tag	Basis of Design	Model	Nominal Cooling Capacity	Cooling Efficiency	Design Outdoor Condition	Design Indoor Condition	Airflow CFM	Refrigerant Type	Sound Pressure	Voltage / Phase		Electrical		Comments
			(BTU/h)	SEER	DB / WB	DB / WB		57.5	(dBA)		MCA	ROCP	МОСР	
CU-1	MITSUBISHI	PUY-A12NHA4	12000	15.2	95 / 75	-	1200	410A	46	208 / 1	13	15	15	2
CU-2	MITSUBISHI	PUY-A12NHA4	12000	15.2	95 / 75	-	1200	410A	46	208 / 1	13	15	15	2
CU-3	MITSUBISHI	PUY-A12NHA4	12000	15.2	95 / 75	-	1200	410A	46	208 / 1	13	15	15	2
ACU-1	MITSUBISHI	PKA-A12HA4	12000	15.2	-	80 / 67	425	410A	43	DC 24V	_	_	_	1
ACU-2	MITSUBISHI	PKA-A12HA4	12000	15.2	-	80 / 67	425	410A	43	DC 24V	_	_	-	1
ACU-3	MITSUBISHI	PKA-A12HA4	12000	15.2	-	80 / 67	425	410A	43	DC 24V	_	-	-	1

Indoor unit recieves power from outdoor unit through manufacturer provided interconnected wiring.

Provide optional wind baffle accessory for operation down to 0°F.

THE DELIVERY OF THIS DRAWING SHOULD NOT BE CONSTRUED TO PROVIDE AN EXPRESS WARRANTY OR GUARANTEE TO ANYONE THAT ALL THE DIMENSIONS AND DETAILS ARE EXACT OR TO INDICATE THAT THE USE OF THIS DRAWING IMPLIES THE REVIEW AND APPROVAL BY THE DESIGN PROFESSIONAL OF ANY FUTURE USE. ANY USE OF THIS INFORMATION WITHOUT THE WRITTEN APPROVAL BY THE DESIGN PROFESSIONAL IS AT THE SOLE RISK AND LIABILITY OF THE USER. THE DESIGN PROFESSIONAL RESERVES THE RIGHT TO REMOVE OUR PROFESSIONAL SEAL AND/OR TITLE BLOCK.

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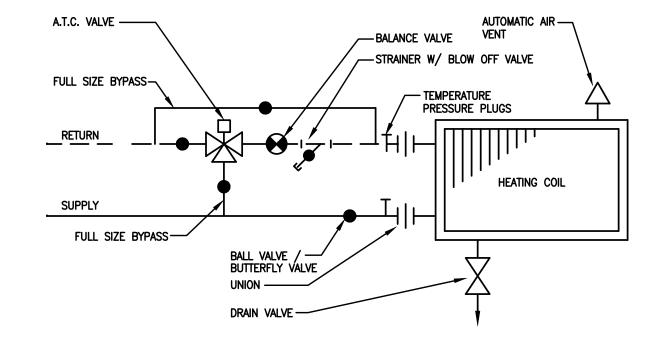
Project Number: 7010.03-22

Sheet Title: DETAILS &


SCHEDULES -MECHANICAL

Sheet Number:


PIPING TO HEATING COILS (2-WAY VALVE)



PIPING TO HEATING COILS (3-WAY VALVE)

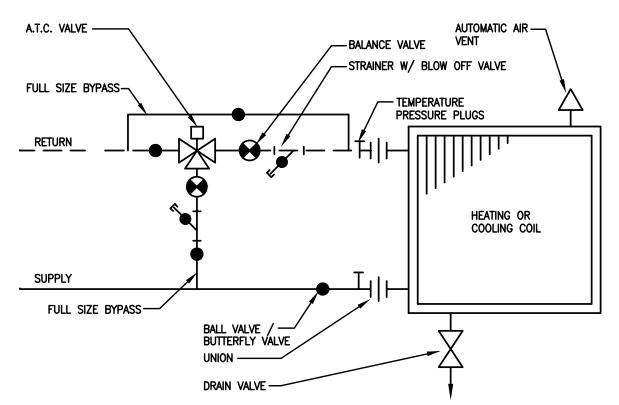

PIPING TO AHU-1 COOLING COIL (3-WAY VALVE)

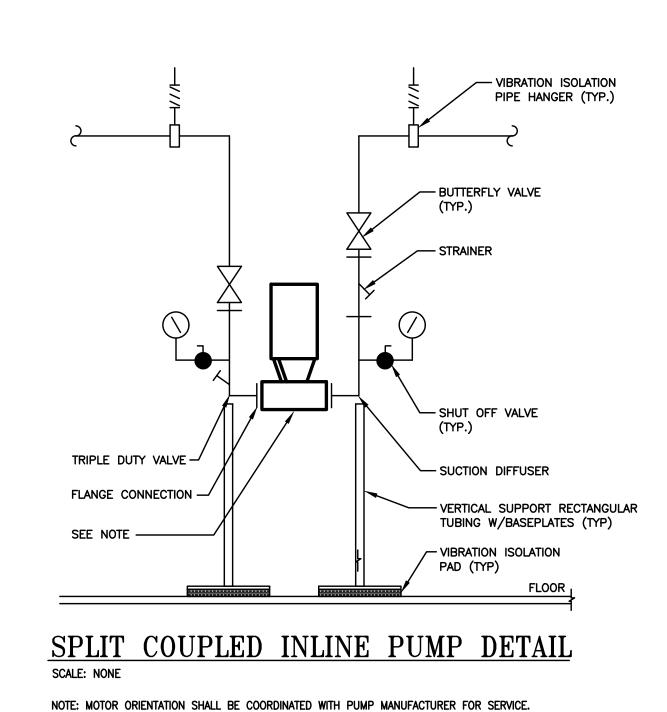


-IF THE LENGTH OF HORIZONTAL RUN IS --- EQUIPMENT DRAIN GREATER THAN 15' INSTALL VENT SAME SIZE AS DRAIN, 10' DOWNSTREAM FROM TRAP. PITCH DOWN TOWARDS -DRAIN @ 1/4' PER FOOT\ -DI-ELECTRIC COUPLING/UNION (IF REQUIRED)

CONDENSATE TRAP

A-B = STATIC PRESSURE

CAPABILITY OF UNIT.

MINIMUM OF 1 1/2".

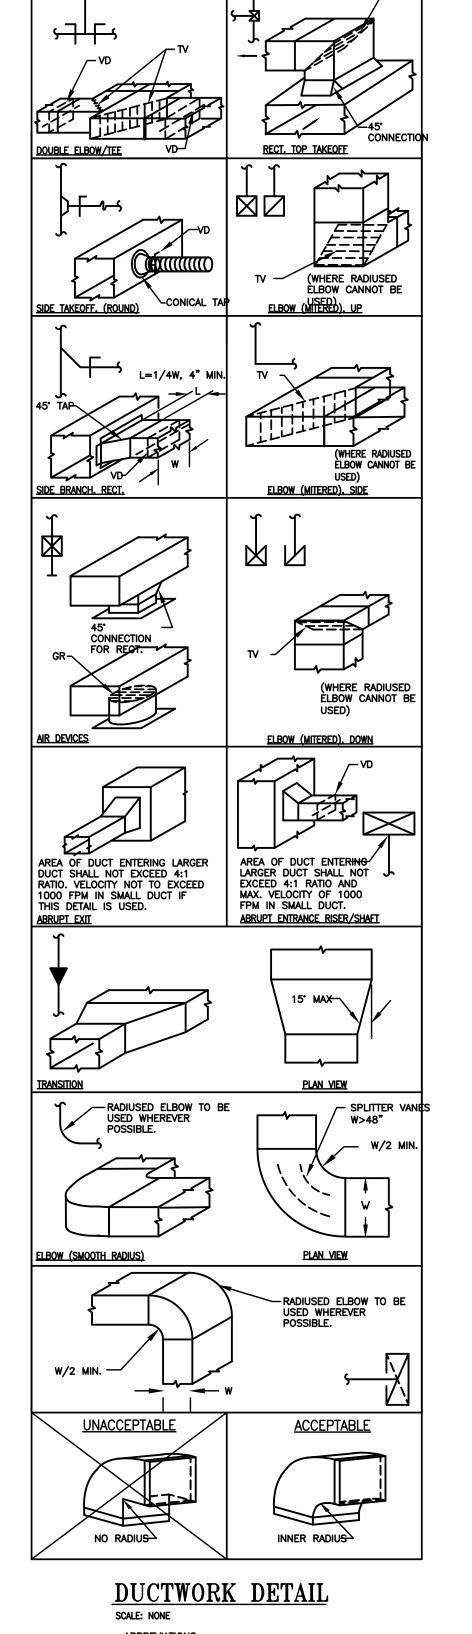

HEATING, VENTILATING, AND AIR CONDITIONING GENERAL NOTES

5. INSULATE REFRIGERANT PIPING WITH 1" ARMAFLEX II INSULATION.

- 1. ALL INTERIOR RECTANGULAR DUCTWORK TO BE GALVANIZED SHEET METAL IN ACCORDANCE WITH SMACNA LOW PRESSURE CONSTRUCTION STANDARD, ALL DUCTMATE INTERIOR RECTANGULAR DUCTWORK TO BE G-60 OR BETTER GALVANIZED STEEL AND ALL EXTERIOR TO BE G-90 OR BETTER GALVANIZED STEEL. ALL DUCTWORK IN MOIST AREAS (KITCHEN, SHOWERS, TOILET ROOMS, POOLS, ETC.) SHALL BE ALUMINUM CONSTRUCTION. ALL DUCTWORK SIZES INDICATED ARE INSIDE DIMENSIONS.
- 2. ALL SUPPLY AND OUTSIDE AIR DUCTWORK SHALL BE INSULATED WITH 2" FIBERGLASS DUCTWRAP WITH FOIL VAPOR BARRIER. ALL SUPPLY, OUTSIDE, AND RETURN AIR DUCTWORK IN UNCONDITIONED AREAS/ATTICS SHALL HAVE 3" FIBERGLASS INSULATION WITH VAPOR BARRIER.
- 3. ALL DUCTWORK TO COMPLY WITH NFPA PAMPHLET 90 A. ALL DUCTWORK SEAMS SHALL BE SEALED WITH DUCT SEALANT. ALL NEW DUCTWORK SECTIONS AND FITTINGS TO BE INSTALLED ON THE PROJECT SHALL BE COVERED AND SEALED FROM DUCT, DIRT, DEBRIS.
- 4. FURNISH AND INSTALL ALL CONTROL WIRING FOR OPERATION OF THE EQUIPMENT. ALL CONCEALED CONTROL WIRING SHALL BE PLENUM RATED. ALL EXPOSED/UNFINISHED AREAS SHALL BE IN EMT CONDUIT. ALL CONTROL WIRING IS BY THE MECHANICAL CONTRACTOR/ATC CONTRACTOR REGARDLESS IF IT IS LINE OR LOW VOLTAGE WIRING, AS LONG AS IT PERFORMS A CONTROL FUNCTION. THE MECHANICAL CONTRACTOR SHALL MAKE AN ALLOWANCE TO COMPENSATE THE ELECTRICAL CONTRACTOR FOR ALL ASSOCIATED COSTS.
- 6. PROVIDE TEST, BALANCE, AND ADJUST REPORT (ALL AIR & HYDRONIC SYSTEMS) AT THE COMPLETION OF THE WORK. BALANCE AIR QUANTITIES AND FLOW RATES TO VALUES ON THE DRAWINGS. SET DAMPER AND VALVE POSITIONS. ALLOW FOR ONE SHEAVE CHANGE PER EACH OF THE HVAC SYSTEMS. PROVIDE TOTAL AND STATIC PRESSURE READINGS, TRAVERSE AT FAN INTLETS AND OUTLETS. READ PUMP PRESSURE, AMPS, GPMS, RPMS AND IDENTIFY OPERATING POINT ON THE IMPELLAR CURVE. TBA CONTRACTOR TO BE INDEPENDENT AND AABC/NEBB CERTIFIED.
- 7. OBTAIN AND PAY FOR BUILDING PERMITS, INSPECTIONS, CONNECTION CHARGES, AND FEES.
- 8. PROVIDE FOR FLEXIBLE CONNECTIONS AT EQUIPMENT.
- 9. PROVIDE SHOP DRAWINGS OF ALL EQUIPMENT FOR REVIEW PRIOR TO ORDERING. COORDINATE ALL ELECTRICAL REQUIREMENTS WITH ELECTRICAL CONTRACTOR AND PHYSICAL DIMENSIONS PRIOR TO SHOP
- 10. SUSPENDED HVAC EQUIPMENT TO BE MOUNTED ON VIBRATION ISOLATION HANGERS. PROVIDE ANY ADDITIONAL SUPPLEMENTAL STEEL NECESSARY TO SUPPORT THE UNITS FROM THE BUILDING STRUCTURAL STEEL OR FRAMING MEMBERS. SUBMIT SHOP DRAWINGS FOR APPROVAL.
- 11. FLOOR/GRADE MOUNTED HVAC EQUIPMENT TO BE MOUNTED ON VIBRATION ISOLATION PADS OR SPRING MOUNTINGS, PROVIDE ANY ADDITIONAL SUPPLEMENTAL STEEL NECESSARY TO SUPPORT THE UNITS. SUBMIT SHOP DRAWINGS FOR APPROVAL.
- 12. CONTRACTOR MAY USE INSULATED FLEXIBLE DUCT RUNOUTS NOT TO EXCEED 10 FEET FOR SUPPLY DUCTWORK ONLY. ALL RETURN AND EXHAUST AIR DUCTWORK TO BE RIGID DUCTWORK. 13. PROVIDE CONDENSATE DRAIN TO ACCEPTABLE CODE APPROVED DISCHARGE POINT. 1-1/2" PVC.(COPPER). ALL CONDENSATE PIPING SHALL HAVE 1/2" FIBERGLASS INSULATION WITH VAPOR BARRIER.
- FURNISH AND INSTALL A CONDENSATE PUMP WITH DISCHARGE CHECK VALVE IF GRAVITY FLOW IS NOT OBTAINABLE, SUBMIT SHOP DRAWING FOR REVIEW AND APPROVAL AND COORDINATE ELECTRICAL
- 14. DIFFUSERS SHALL BE SQUARE FACE, STEEL, PLAQUE TYPE, WITH ROUND NECK AND VOLUME CONTROL DEVICE. CARNES, TITUS, ANEMOSTAT, TUTTLE AND BAILEY, METAL—AIRE. FACE OF DIFFUSER TO BE
- 15. REGISTERS SHALL BE STEEL CONSTRUCTION, EXTRUDED STEEL BARS, 45 DEGREE ANGLE, 3/4" BLADE SPACING, MITERED FRAME WITH ADJUSTABLE DAMPER. GRILLES SHALL BE THE SAME WITHOUT DAMPER. LOW REGISTERS TO BE HEAVY DUTY STEEL/EXTRUDED ALUMINUM CONSTRUCTION. AIR DEVICES IN MOIST AREAS (KITCHEN, TOILET ROOMS, SHOWERS, POOLS, ETC) TO BE ALUMINUM.
- 16. FURNISH AND INSTALL FIRE DAMPERS IN RATED WALL/FLOOR/SHAFT ASSEMBLIES WHERE INDICATED ON THE MECHANICAL PLANS. FIRE DAMPERS SHALL BE INSTALLED IN ACCORDANCE WITH THE UL LISTING FOR THE DAMPER AND AS DETAILED AS ON THE DRAWING. THE DAMPERS SHALL BE SET IN A STEEL SLEEVE AND PROVIDED WITH BREAKAWAY CONNECTIONS. DAMPERS SHALL BE 1-1/2 HR RATED. FURNISH AND INSTALL SMOKE DAMPERS IN ALL SMOKE RATED WALLS/PARTITIONS AS PER ARCHITECTURAL PLANS. COORDINATE LOCATIONS AND POWER REQUIREMENTS WITH ELECTRICAL/FIRE
- 17. PROVIDE INSULATED PREFABRICATED ROOF CURB FOR ROOF MOUNTED EQUIPMENT, DUCTWORK, AND PIPING AS MANUFACTURED BY THE ROOF MOUNTED EQUIPMENT MANUFACTURER, PATE, OR APPROVED EQUAL. ALL PIPING ROOF PENETRATIONS SHALL HAVE ROOF CURBS. ALL ROOF CURBS SHALL BE SECURED TO THE ROOF AND COORDINATED WITH THE OWNER'S ROOFING CONTRACTOR.
- 18. THREE (3) PHASE STARTERS TO BE PROVIDED BY MECHANICAL CONTRACTOR. MAGNETIC ACROSS THE LINE, AUXILIARY CONTACTS. SINGLE PHASE STARTERS BY ELECTRICAL CONTRACTOR. ALL STARTERS ARE TO BE INSTALLED BY THE ELECTRICAL CONTRACTOR.
- 19. ALL WORK TO BE CONCEALED UNLESS OTHERWISE INDICATED.
- 20. SUBMIT SHOP DRAWINGS OF ALL SHEET METAL FOR REVIEW. DRAWINGS SHALL BE NOT LESS THAN 1/4" SCALE AND SHOW ALL STEEL, PIPING, CONDUIT, LIGHTING, SPRINKLER, EQUIPMENT AND ARCHITECTURAL FEATURES. DUCTWORK IS TO BE SHOWN DOUBLE LINE. SHOW DETAIL OF FIRE DAMPER. SHEET METAL SHOP DRAWING SHALL BE UTILIZED FOR CONTRACTORS COORDINATION DRAWINGS AND SUBMIT FOR REVIEW AND APPROVAL PRIOR TO INSTALLATION. IF SHEET METAL SHOP DRAWINGS ARE NOT SUBMITTED OR IF THE CONTRACTOR INSTALLS THE DUCTWORK WITHOUT APPROVALS, THE CONTRACTOR SHALL ASSUME ALL RESPONSIBILITIES AND FIELD COORDINATION AND PAY ANY ASSOCIATED COSTS ASSOCIATED WITH DUCTWORK INSTALLATION DEFICIENCIES AND FIELD COORDINATION ISSUES.
- 21. PROPERLY INSTRUCT OWNERS PERSONNEL IN THE OPERATION AND MAINTENANCE OF ALL SYSTEMS AND EQUIPMENT. PROVIDE THREE INSTRUCTIONS AND MAINTENANCE MANUALS. SUBMIT MANUALS FOR REVIEW PRIOR TO OPERATING INSTRUCTION PERIOD.
- 22. COORDINATE LOCATIONS AND ROUGH-IN REQUIREMENTS WITH OTHER TRADES PRIOR TO INSTALLATION.
- 23. COORDINATE ELECTRICAL REQUIREMENTS WITH THE ELECTRICAL CONTRACTOR PRIOR TO PURCHASING EQUIPMENT. VERIFY VOLTAGES AND AMPERAGES FOR FEEDERS.
- 24. IF THE CONTRACTOR ELECTS TO SUBMIT ALTERNATE EQUIPMENT, MANUFACTURERS, SYSTEMS, METHODS, OR MATERIALS, NOT SPECIALLY IDENTIFIED IN THE DRAWINGS AND SPECIFICATIONS, IT IS THE CONTRACTORS RESPONSIBILITY TO COORDINATE THE WORK WITH OTHER TRADES AND PAY FOR ANY ADDITIONAL COSTS WITH THE SUBSTITUTION OR CHANGE.
- 25. PROVIDE RECORD AS-BUILT DRAWINGS AT COMPLETION OF WORK. SUBMIT TO OWNER AND ENGINEER FOR REVIEW AND APPROVAL.
- 26. ALL FINISHES RELATED TO MECHANICAL EQUIPMENT, TERMINAL EQUIPMENT, AIR DEVICES, PERIMETER HEATERS, LOUVERS, ACCESS PANELS, EXPOSED WIREMOLD/RACEWAYS, ETC. SHALL BE COORDINATED AND SELECTED BY THE ARCHITECT/OWNER/ENGINEER PRIOR TO SHOP DRAWING SUBMISSION, ORDERING, AND INSTALLATION.
- 27. FINAL LOCATIONS OF ALL THERMOSTATS, ACCESS PANELS, SPACE SENSORS, DETECTION DEVICES, ETC. IN FINISHED SPACES SHALL BE COORDINATED AND APPROVED BY THE ARCHITECT/OWNER PRIOR TO ROUGH-IN AND INSTALLATION.
- 28. ALL HEATING HOT WATER SUPPLY/RETURN PIPING AND CHILLED WATER SUPPLY/RETURN PIPING PIPING SHALL BE SCHEDULE 40 STEEL PIPING (2" AND BELOW WITH THREADED FITTINGS, 2 1/2" AND ABOVE WITH WELDED FLANGE FITTINGS OR GROOVED JOINTS FOR VICTAULIC FITTINGS). FURNISH AND INSTALL DIELECTRIC UNIONS AT DISSIMILAR PIPING MATERIAL CONNECTIONS. ALL PIPING TO BE SUPPORTED ON ADJUSTABLE CLEVIS TYPE HANGERS AND GALVANIZED PIPE SHIELDS. PIPING SUPPORTS SHALL BE SPACED AS PER PIPING MANUFACTURER'S/SUPPORT MANUFACTURER'S REQUIREMENTS. PIPING INSULATION SHALL BE CONTINUOUS AND SEALED AT THE JOINTS PER MANUFACTURER REQUIREMENTS AND SHALL NOT BE BROKEN AT THE HANGERS OR FITTINGS. PIPE SHIELD SHALL BE INSTALLED BETWEEN THE PIPING INSULATION AND HANGERS. NO PIPING SHALL RUN OVER ELECTRICAL SWITCHGEAR, ELECTRICAL PANELS, OR SUBSTATIONS, CONTRACTOR TO FURNISH AND INSTALL PIPING IDENTIFICATIONS (STENCIL OR SNAP-ON LABELS) FLOW DIRECTION, AT 25 FT INTERVALS. FURNISH AND INSTALL VALVE TAGS (METAL TAG CHAINED TO VALVE WITH VALVE NUMBER) AND PIPING DIAGRAMS WITH VALVE LOCATIONS AND VALVE TAG NUMBERS IDENTIFIED.
- 29. CONTRACTOR TO PROVIDE MANUFACTURER'S START-UP OF ALL HVAC EQUIPMENT/SYSTEM.
- 30. WATER SYSTEMS START-UP: FILL SYSTEM AND THOROUGHLY FLUSH ALL SEDIMENT, DIRT, PARTICLES, AND ANY OTHER MATERIAL FROM THE SYSTEM. REMOVE ALL AIR FROM THE SYSTEM. THIS WILL REQUIRE SEVERAL BLEEDING SEQUENCES. PROVIDE AIR VENTS AS REQUIRED. CLEAN ALL STRAINERS AFTER A THOROUGH FLUSHING. PROVIDE CHEMICAL TREATMENTS FOR THE FIRST YEAR OF OPERATION INCLUDING ALL NECESSARY TASKS, CHEMICALS, ADDITIVES, AND SERVICE VISITS.
- 31. ALL HEATING HOT WATER SUPPLY/RETURN PIPING AND CHILLED WATER SUPPLY/RETURN PIPING SHALL BE INSULATED WITH FIBERGLASS INSULATION WITH AN ALL SERVICE JACKET (FLAME SPREAD OF 25, SMOKE DEVELOPED RATING OF 50, THERMAL CONDUCTIVITY OF 0.27 AT 90 DEGREE FAHRENHEIT, AND THICKNESS PER ASHRAE STANDARDS) MANUFACTURER: JOHNS MANVILLE MICRO-LOK HP OR PRIOR A. HEATING HOT WATER S&R: 1 1/2" & BELOW PIPING- 1 1/2" INSULATION, 2" & ABOVE PIPING-2" INSULATION
- B. CHILLED WATER S&R: 1 1/2" & BELOW PIPING-1 1/2" INSULATION, 2" TO 8" PIPING-2" INSULATION C. PIPING OUTSIDE OF THE BUILDING ENVELOPE SHALL HAVE AN ADDITIONAL 1/2" INSULATION, WEATHERPROOF UV RESISTANT JACKETING, AND ELECTRICAL HEAT TRACING.
- 40. NO PVC PIPING IS PERMITTED IN RETURN AIR PLENUMS. ALL PVC PIPING LOCATED IN PLENUMS SHALL BE INSULATED WITH 1" PLENUM RATED FIBERGLASS INSULATION WITH VAPOR BARRIER AND COMPLIES WITH THE FLAME SPREAD OF 25 AND SMOKE DEVELOPED RATING OF 50.
- 41. CONTRACTOR SHALL VISIT SITE PRIOR TO BID SUBMISSION AND BECOME AWARE OF ALL CONDITIONS WHICH MAY AFFECT THE WORK. SUBMISSION OF BID WILL BE DEEMED EVIDENCE OF HAVING COMPLETED WITH THE REQUIREMENTS. CONTRACTOR TO INCLUDE ALL ASSOCIATED COSTS (MATERIALS/LABOR) AS A RESULT OF THE SITE VISIT INSPECTION.
- 42. DRAWINGS AND SPECIFICATIONS ARE INTENDED TO BE TAKEN AS A WHOLE. IF A CONFLICT OR CONTRADICTION EXISTS BETWEEN THE DRAWINGS AND SPECIFICATIONS, THE MORE STRINGENT SHALL APPLY.
- THE ARCHITECT'S AND ENGINEER'S INTERPRETATION OF THE DOCUMENTS SHALL BE BINDING UPON THE CONTRACTOR. 43. ALL EXTERIOR WALL/ROOF PENETRATIONS SHALL BE SEALED AIR/WATER TIGHT. ALL PIPING PASSING THROUGH WALL OR FLOOR PENETRATIONS SHALL HAVE SLEEVES. ALL WALL OR FLOOR RATED
- PENETRATIONS SHALL BE SEALED WITH FIRE RATED SEALANT FORMED IN PLACE BY 3M OR HILTI. 44. FURNISH AND INSTALL ACCESS DOORS FOR ALL VALVES, DAMPERS, DEVICES, CONTROLLERS, ETC WHICH MAY NEED SERVICE AND ACCESS. ACCESS PANELS SHALL BE 16 GAUGE STEEL FRAME, 20 GAUGE

HINGED DOOR, LOCKABLE AND FIRE RATED (WHEN IN RATED WALLS, FLOORS, "B" LABEL, 1 1/2 HRS). FINISH AS SELECTED BY THE ARCHITECT. **EQUALIZING GRID** TURNING VANES

VOLUME DAMPER AIR TURN OR EXTRACTOR

ACCEPTABLE DISCHARGE

RECEPTOR. JANITOR'S SINK,

LOOSEWELL, OR AS INDICATED


THERMOMETER REDUCER-BALANCING VALVE STRAINER W/ ---BLOW OFF VALVE -MANIFOLD FURNISHED & -----— 3-WAY TEMPERING/ IN-LINE CIRCUILATOR SEE INSTALLED BY CONTRACTOR BALL VALVE (TYP)-CONTROL VALVE PLANS FOR SIZE PER MFR'S REQUIREMENTS. UNION (TYP) SEE REQUIREMENTS BELOW FOR QUANTITIES OF MANIFOLDS HEATING HOT WATER— SUPPLY/RETURN PIPING-SEE PLAN FOR PIPE SIZING TYPICAL PIPING ZONES CONTRACTOR — MANIFOLD FURNISHED & ---TO REFER TO PLANS FOR QUANTITIES, INSTALLED BY CONTRACTOR LENGTH OF TUBING, CAPACITIES, & PER MFR'S REQUIREMENTS. ZONES AS RECOMMENDED BY SEE REQUIREMENTS BELOW MANUFACTURER FOR QUANTITIES OF MANIFOLDS

TYPICAL UNDERSLAB HOT WATER HEATING SYSTEM RISER DIAGRAM

1. ALL INSTALLATIONS TO BE IN ACCORDANCE WITH MANUFACTURER'S REQUIREMENTS. CONTRACTOR TO COORDINATE WORK & OBTAIN THE APPROVAL OF THE MANUFACTURER PRIOR TO ROUGH-IN AND SHOP

DRAWING SUBMISSION.

- 2. UNDERSLAB HW PIPING LAYOUT INDICATED ON THE FLOOR PLANS IS ONLY DIAGRAMMATIC. CONTRACTOR IS TO OBTAIN THE SERVICES OF THE MANUFACTURER AND COORDINATE THE PIPING LAYOUT. PIPING LAYOUT SHALL BE IN ACCORDANCE WITH MANUFACTURERS RECOMMENDATIONS.
- 3. UNDERSLAB HEATING SYSTEM IS BASED ON UPONOR OR APPROVED EQUAL. CONTRACTOR IS TO FURNISH & INSTALL ALL THE NECESSARY MATERIALS. LABOR AND APPURTANCES REQUIRED TO OBTAIN A FULLY OPERABLE. EVENLY DISTRIBUTED UNDERFLOOR HEATING SYSTEM.

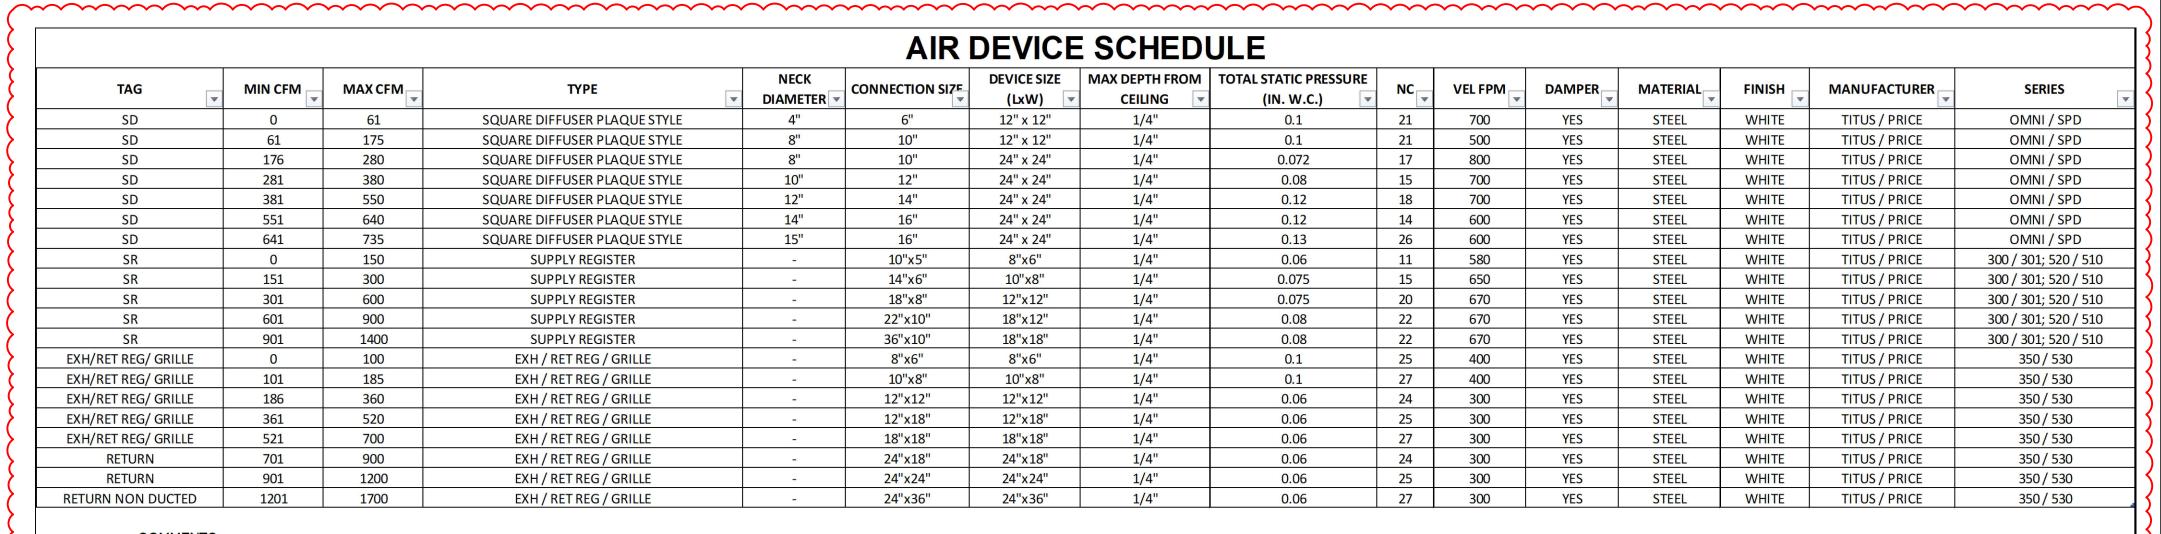

COMMENTS:

- 1. USE SCHEDULE SIZE UNLESS OTHERWISE NOTED.
- 2. USE ALTERNATE SIZE WHEN APPROVED BY ENGINEER.
- 3. PROVIDE VOLUME DAMPER AT TRUNK DUCT CONNECTION. 4. ALL SUPPLY REGISTERS TO BE DOUBLE DEFLECTION TYPE.
- 5. ALUMINUM DEVICES ARE TO BE PROVIDED IN MOIST AREAS, I.E. TOILET ROOMS.
- 6. FOR LAY-IN CEILING PROVIDE A 2'x2' PAN FOR A 12"x12" FACE SIZE DIFFUSERS. 7. BRANCH DUCT DIAMETER SHALL BE REDUCED AT COLLAR CONNECTIONS TO DIFFUSER.

8. EACH AIR DEVICE SHALL HAVE A MOUNTING FLANGE SPECIFICALLY SELECTED FOR THE PARTICULAR TYPE OF CEILING FINISH.

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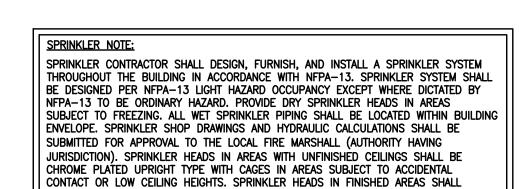
BASEMENT FLOOR PLAN -SANITARY

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BASEMENT FLOOR PLAN - SERVICE PIPING

SCALE: 1/8"=1'-0"



BE CONCEALED. SPRINKLER HEADS IN AREAS WITHOUT A CEILING SHALL BE SEMI-RECESSED PENDANT TYPE. PROVIDE DRY SYSTEM FOR BUILDING OVERHANGS.

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BASEMENT
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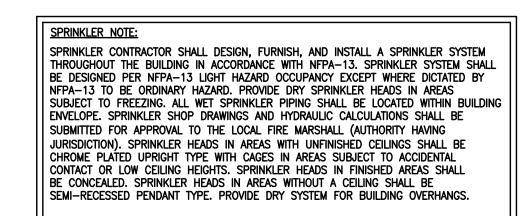
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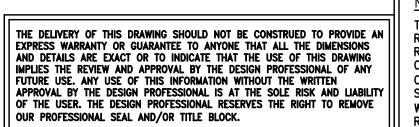
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Project:

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rawn: CK/MW/DE/KG


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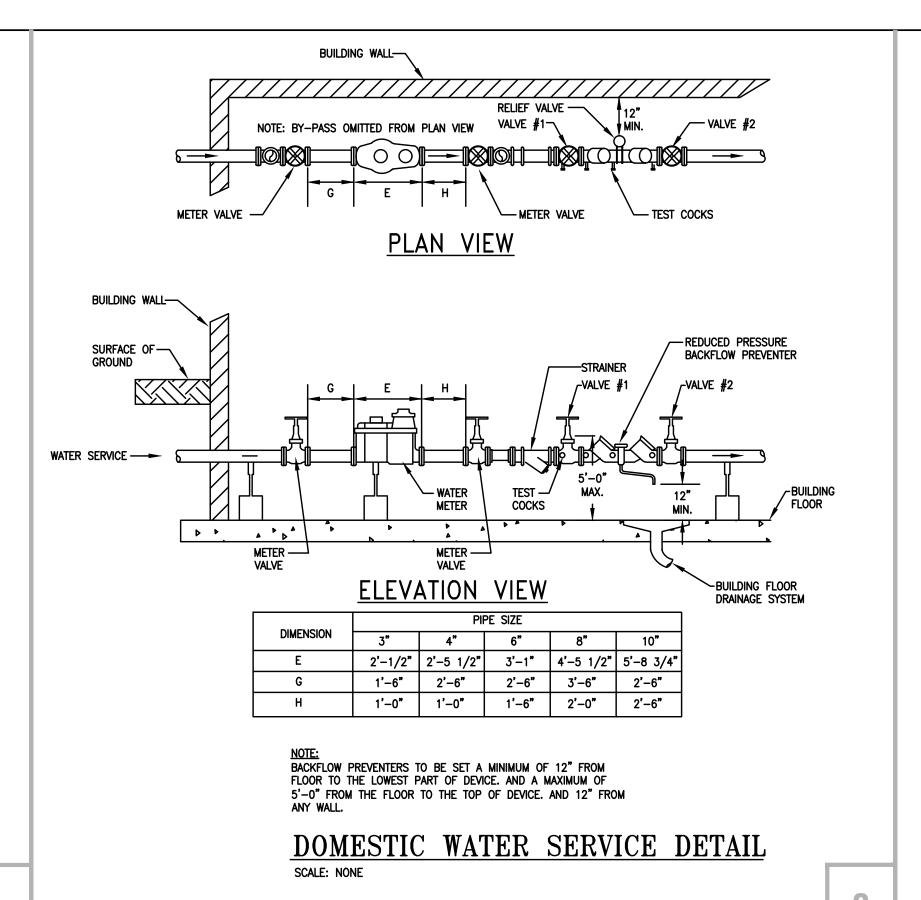
Sheet Title:

FIRST FLOOR PLAN - SERVICE PIPING

Sheet Number:

P1.3



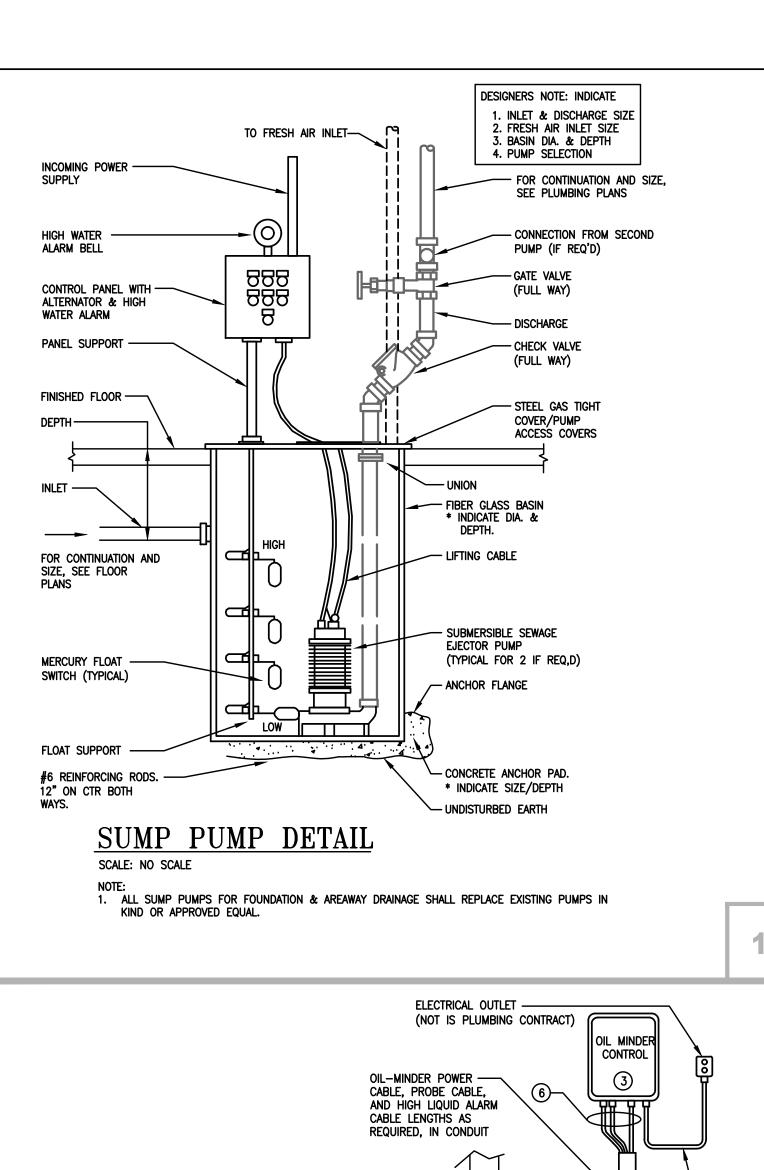

DRY PIPE SYSTEM

UNION/ ORIFICE

SYSTEM

ALL VALVES ARE TO BE FURNISHED WITH

SPRINKLER RISER DIAGRAM - WITH DRY PIPE VALVE

TAMPER SWITCHES

TO EXTERIOR ALARM & CONTACT FOR FIRE -

ALARM PANEL. EXTERIOR ALARM TO CONSIST

LOCAL JURISTICTION. WHERE NO FIRE ALARM SYSTEM IS PROVIDED SPRINKLER CONTRACTOR TO INCLUDE WIRING & DEVICE.

OF BELL OR STROBE AS REQUIRED BY

WHEN AVAILABLE

(TYPICAL)

- LOW PRESSURE ALARM

- VALVES NORMALLY OPEN

RISER MOUNT OR

10


BASE MOUNT


- VALVE CLOSED EXCEPT


FOR FILLING SYSTEM


— DRYPIPE VALVE


SWITCH

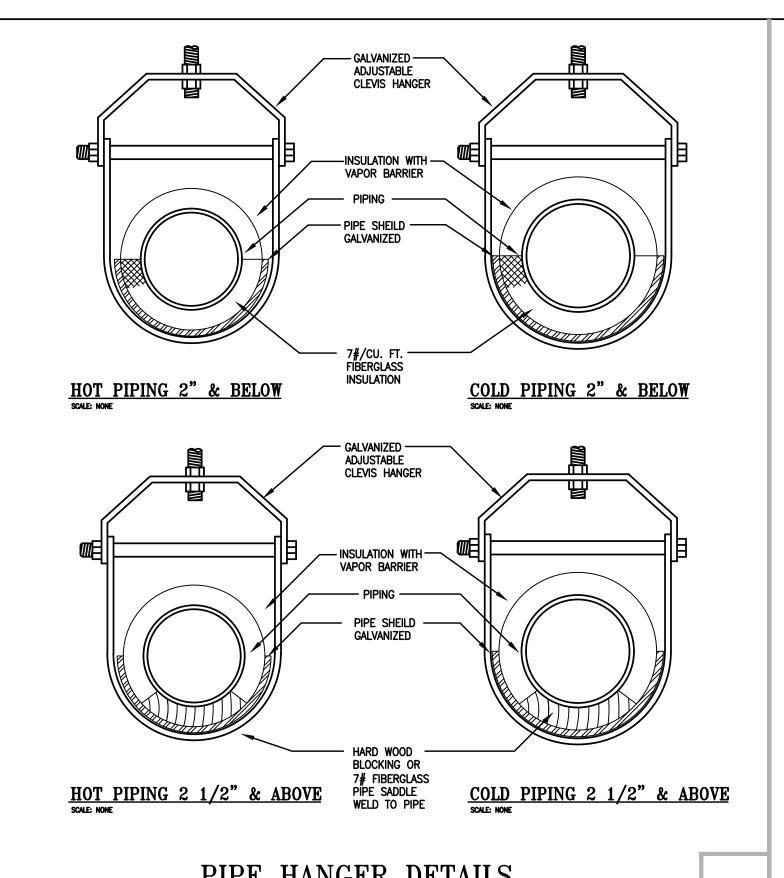

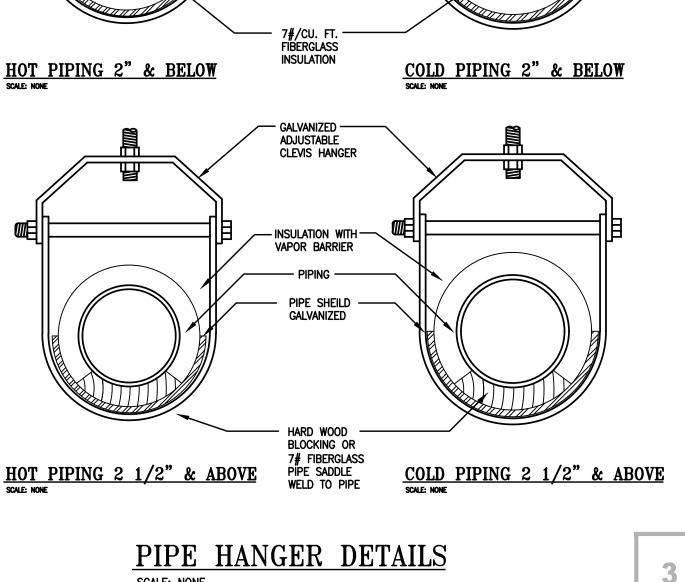

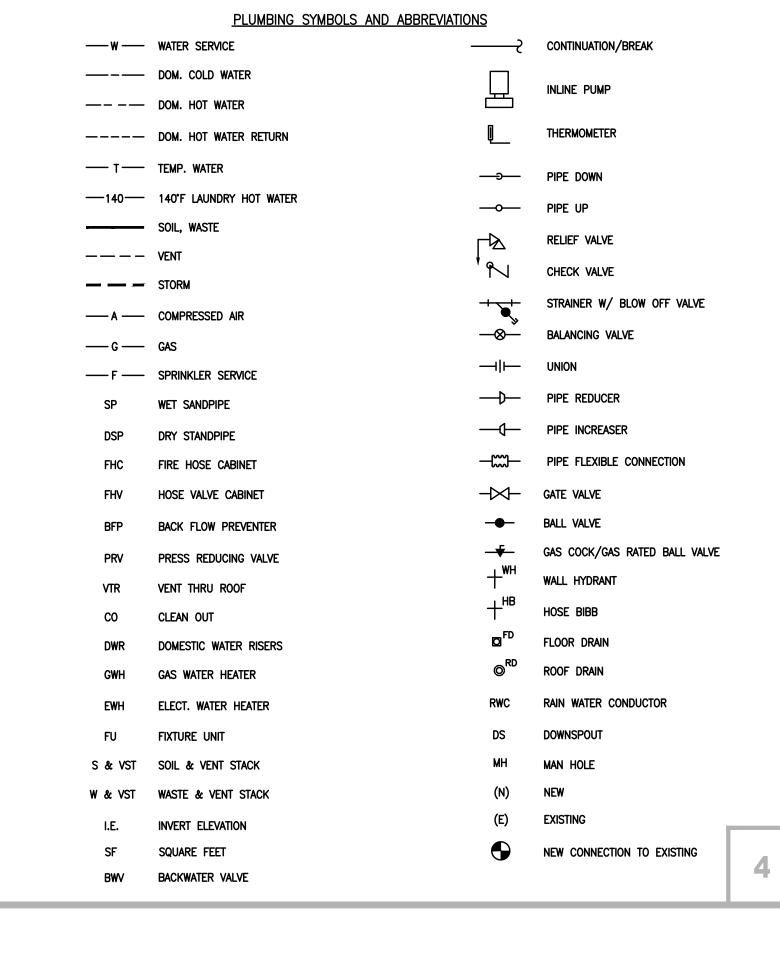

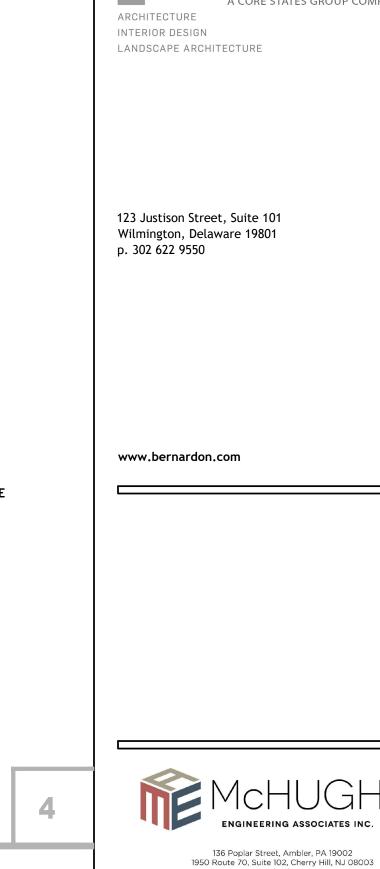

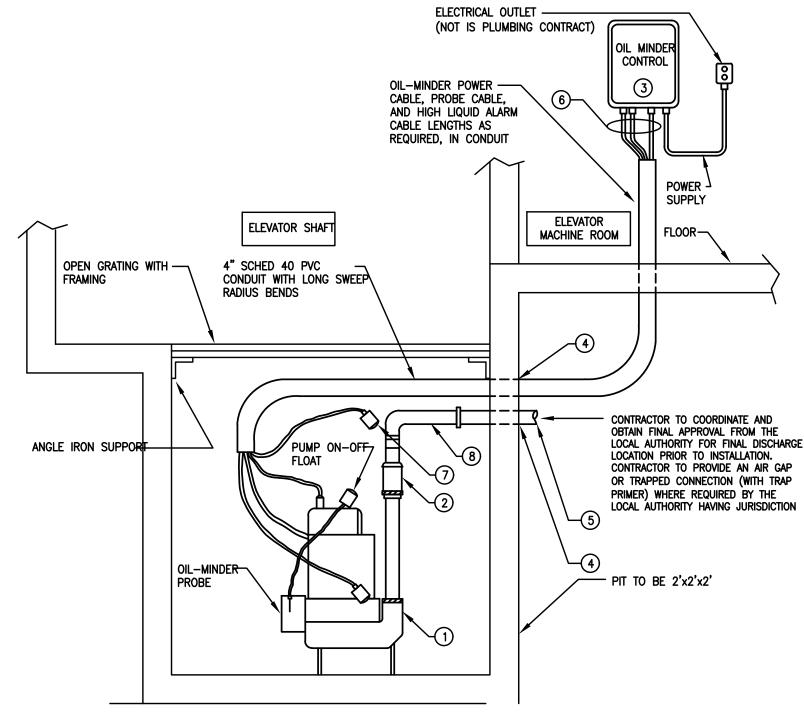



1) STANCOR MODEL SE-50 SUBMERSIBLE EFFLUENT PUMP .5HP, 115 VOLT, 3600 RPM, 2" DISCHARGE CONNECTION, 50 GPM AT 20 FT. HEAD.

(2) STANCOR CHECK VALVE

(4) WATERTIGHT SLEEVE


STANCOR OIL-MINDER 115V, 1 PHASE CONTROL SYSTEM WITH OPTIONAL BUILT-IN AUDIBLE AND VISUAL ALARM WHEN PUMP DOES NOT RUN DUE TO OIL IN PIT OR HIGH LIQUID CONDITION. PROVIDE SILENCING BUTTON FOR AUDIBLE ALARM BUILT INTO PANEL. PANEL SHALL HAVE ADDITIONAL CONTACT FOR REMOTE ALARM LOCATION.

(5) ALL BURIED PUMP PRESSURE DISCHARGE PIPING SHALL BE PROTECTED WITH TAPECOAT CT CORROSION PROTECTION TAPE

(6) OIL MINDER POWER CABLE, PROBE CABLE, AND HIGH LIQUID ALARM CABLE

(7) HIGH LIQUID ALARM FLOAT WITH CLAMP DEVICE TO MOUNT TO PUMP DISCHARGE PIPING (8) PROVIDE UNION AND SHUT-OFF IN DISCHARGE.

1. PROVIDE A MINIMUM OF 5 FT. EXTRA OF EACH CABLE (SLACK) ROLLED AND CLAMPED TO THE DISCHARGE PIPE TO ALLOW FOR THE REMOVAL OF THE PUMP FROM THE PIT. 2. ITEMS 1,2,3,6, & 7 ARE STANCOR PRODUCTS WHICH ARE TO BE PURCHASED & INSTALLED BY THE CONTRACTOR. STANCOR INC.

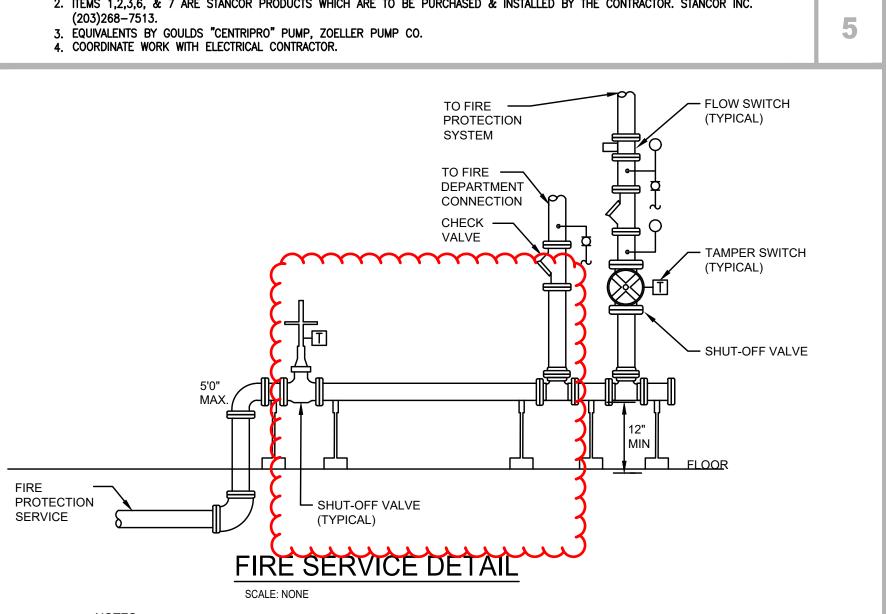


OF DEVICE. AND A MAXIMUM OF 5'-0" FROM THE FLOOR TO THE TOP OF DEVICE. AND 12" FROM


2. CONTRACTOR TO PROVIDE PRESSURE REDUCING VALVE IF PRESSURE EXCEEDS 80 PSI.

3. CONTRACTOR TO COORDINATE INSTALLATION REQUIREMENTS WITH LOCAL UTILITY

COMPANY.

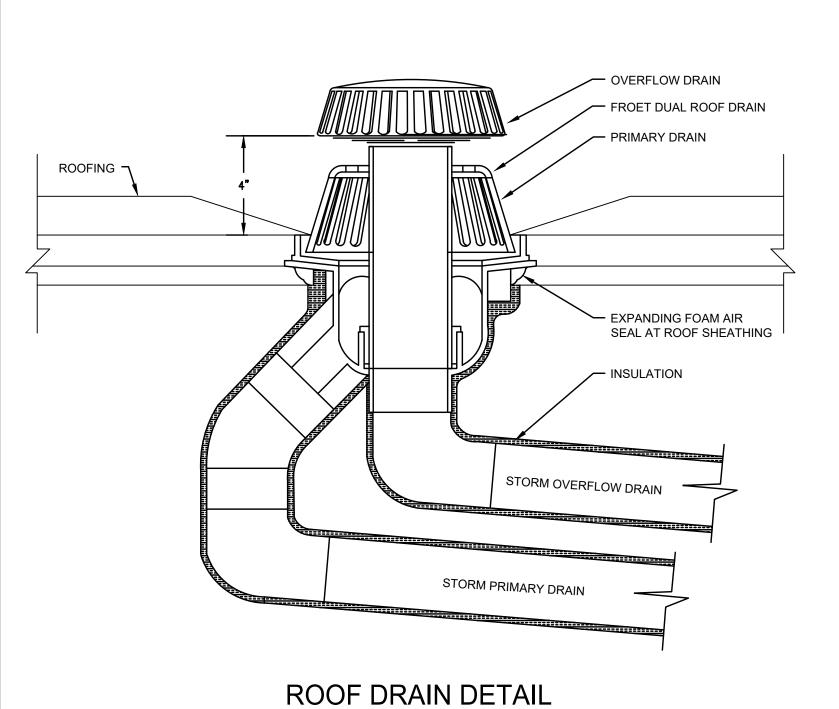


SCALE: NONE

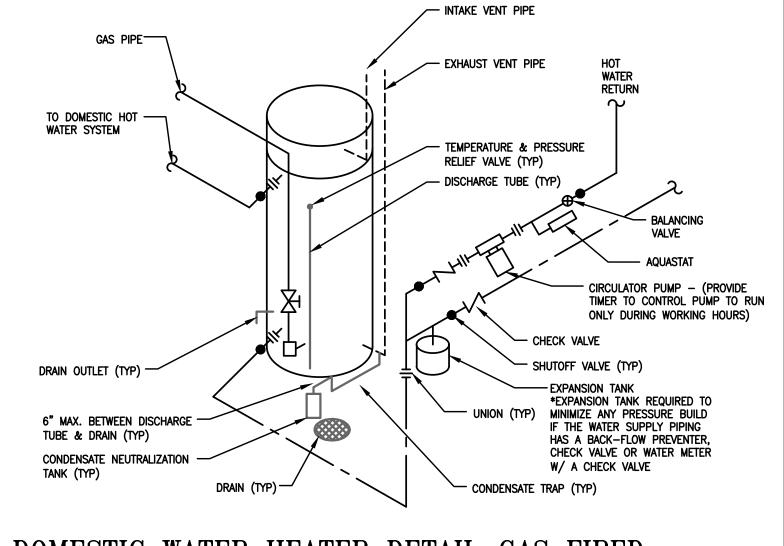

DOMESTIC WATER HEATER DETAIL-GAS FIRED SCALE: NONE


EXPANSIO	N TAI	NK SIZE	SCHED	ULE	
WATER HEATER GALLONS	EXTROL TOTAL	SIZE GALLONS ACCEPTANCE	DIAMETER	HEIGHT	CONN. SIZE
1 TO 50	2	.9	8"	12 1/2"	3/4"
51 TO 100	4.4	2.4	11"	15"	3/4"

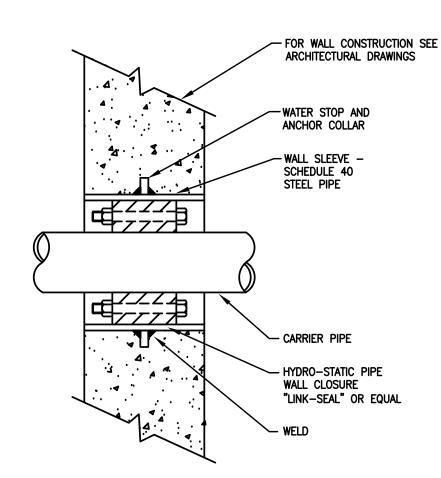

WATERTIGHT WALL PENETRATION DETAIL

ROOF VENT DETAIL

FITTING IS OF THE COUPLING TYPE THAT PERMITS STACK EXTENSION TO THE DESIRED HEIGHT. COUNTER FLASHING FITTING. J.R. SMITH FIG. 1740C OR 1750T.

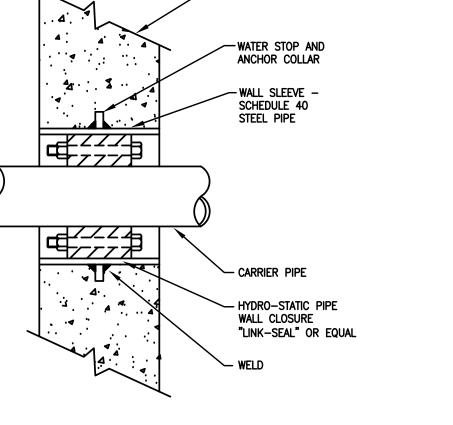

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DETAILS & SCHEDULES -**PLUMBING**

Sheet Number:

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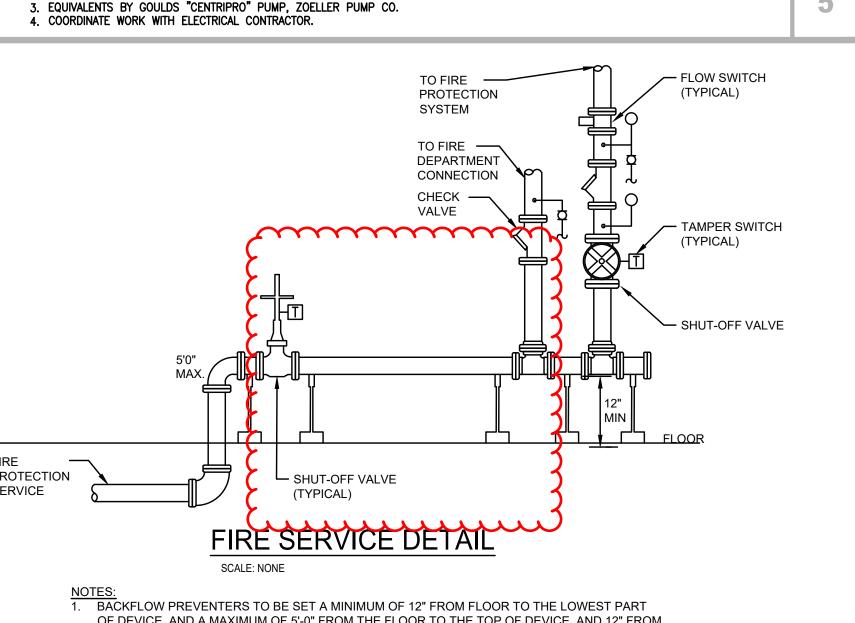
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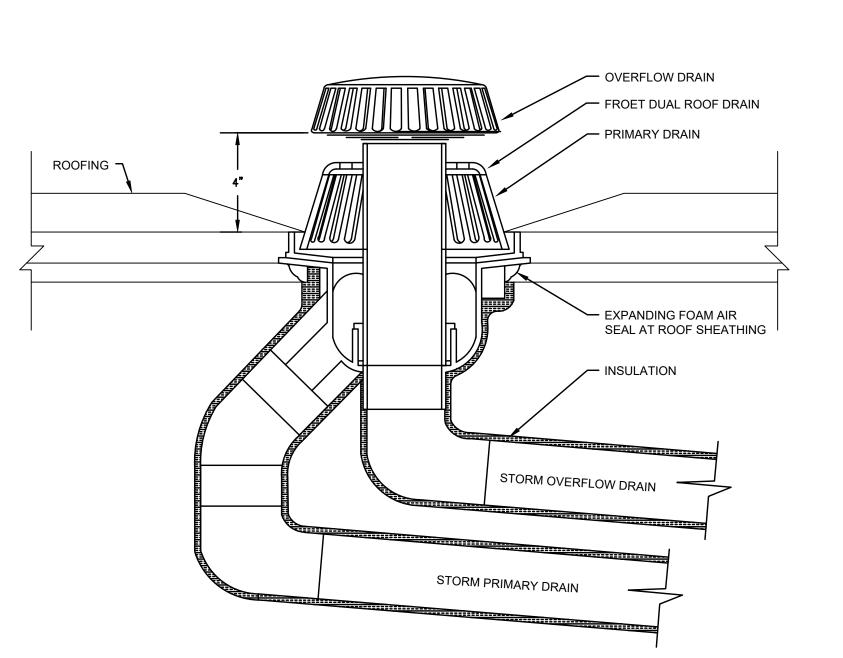
TYPE VENT COUNTER

ROOF BASE FLASHING BY

ROOFING CONTRACTOR

(REFER TO ARCH DWG)






ELEVATOR SHAFT (IF 2ND ELEVATOR) TO SPRINKLER SYSTEM ------SPRINKLER TO FIRE ALARM _ ELEVATOR EQUIPMENT ROOM TAMPER SWITCH ----EXPOSED OS&Y GATE ——
VALVE, SEE PLAN FOR SPRINKLER PIPING — OUTSIDE OF ELEVATOR SHAFT -SIDEWALL SPRINKLER HEAD (200°F) AT BASE OF PIT FOR HYDRAULIC ELEVATORS PER AND ELEVATOR EQUIPMENT ROOM NFPA 13 & AUTHORITIES HAVING JURISDICTION. ELEVATOR SPRINKLER PIPING DIAGRAM

SPRINKLER PIPING OUTSIDE OF ELEVATOR

HEAD (200°F) AT TOP OF SHAFT

ELEVATOR SHAFT

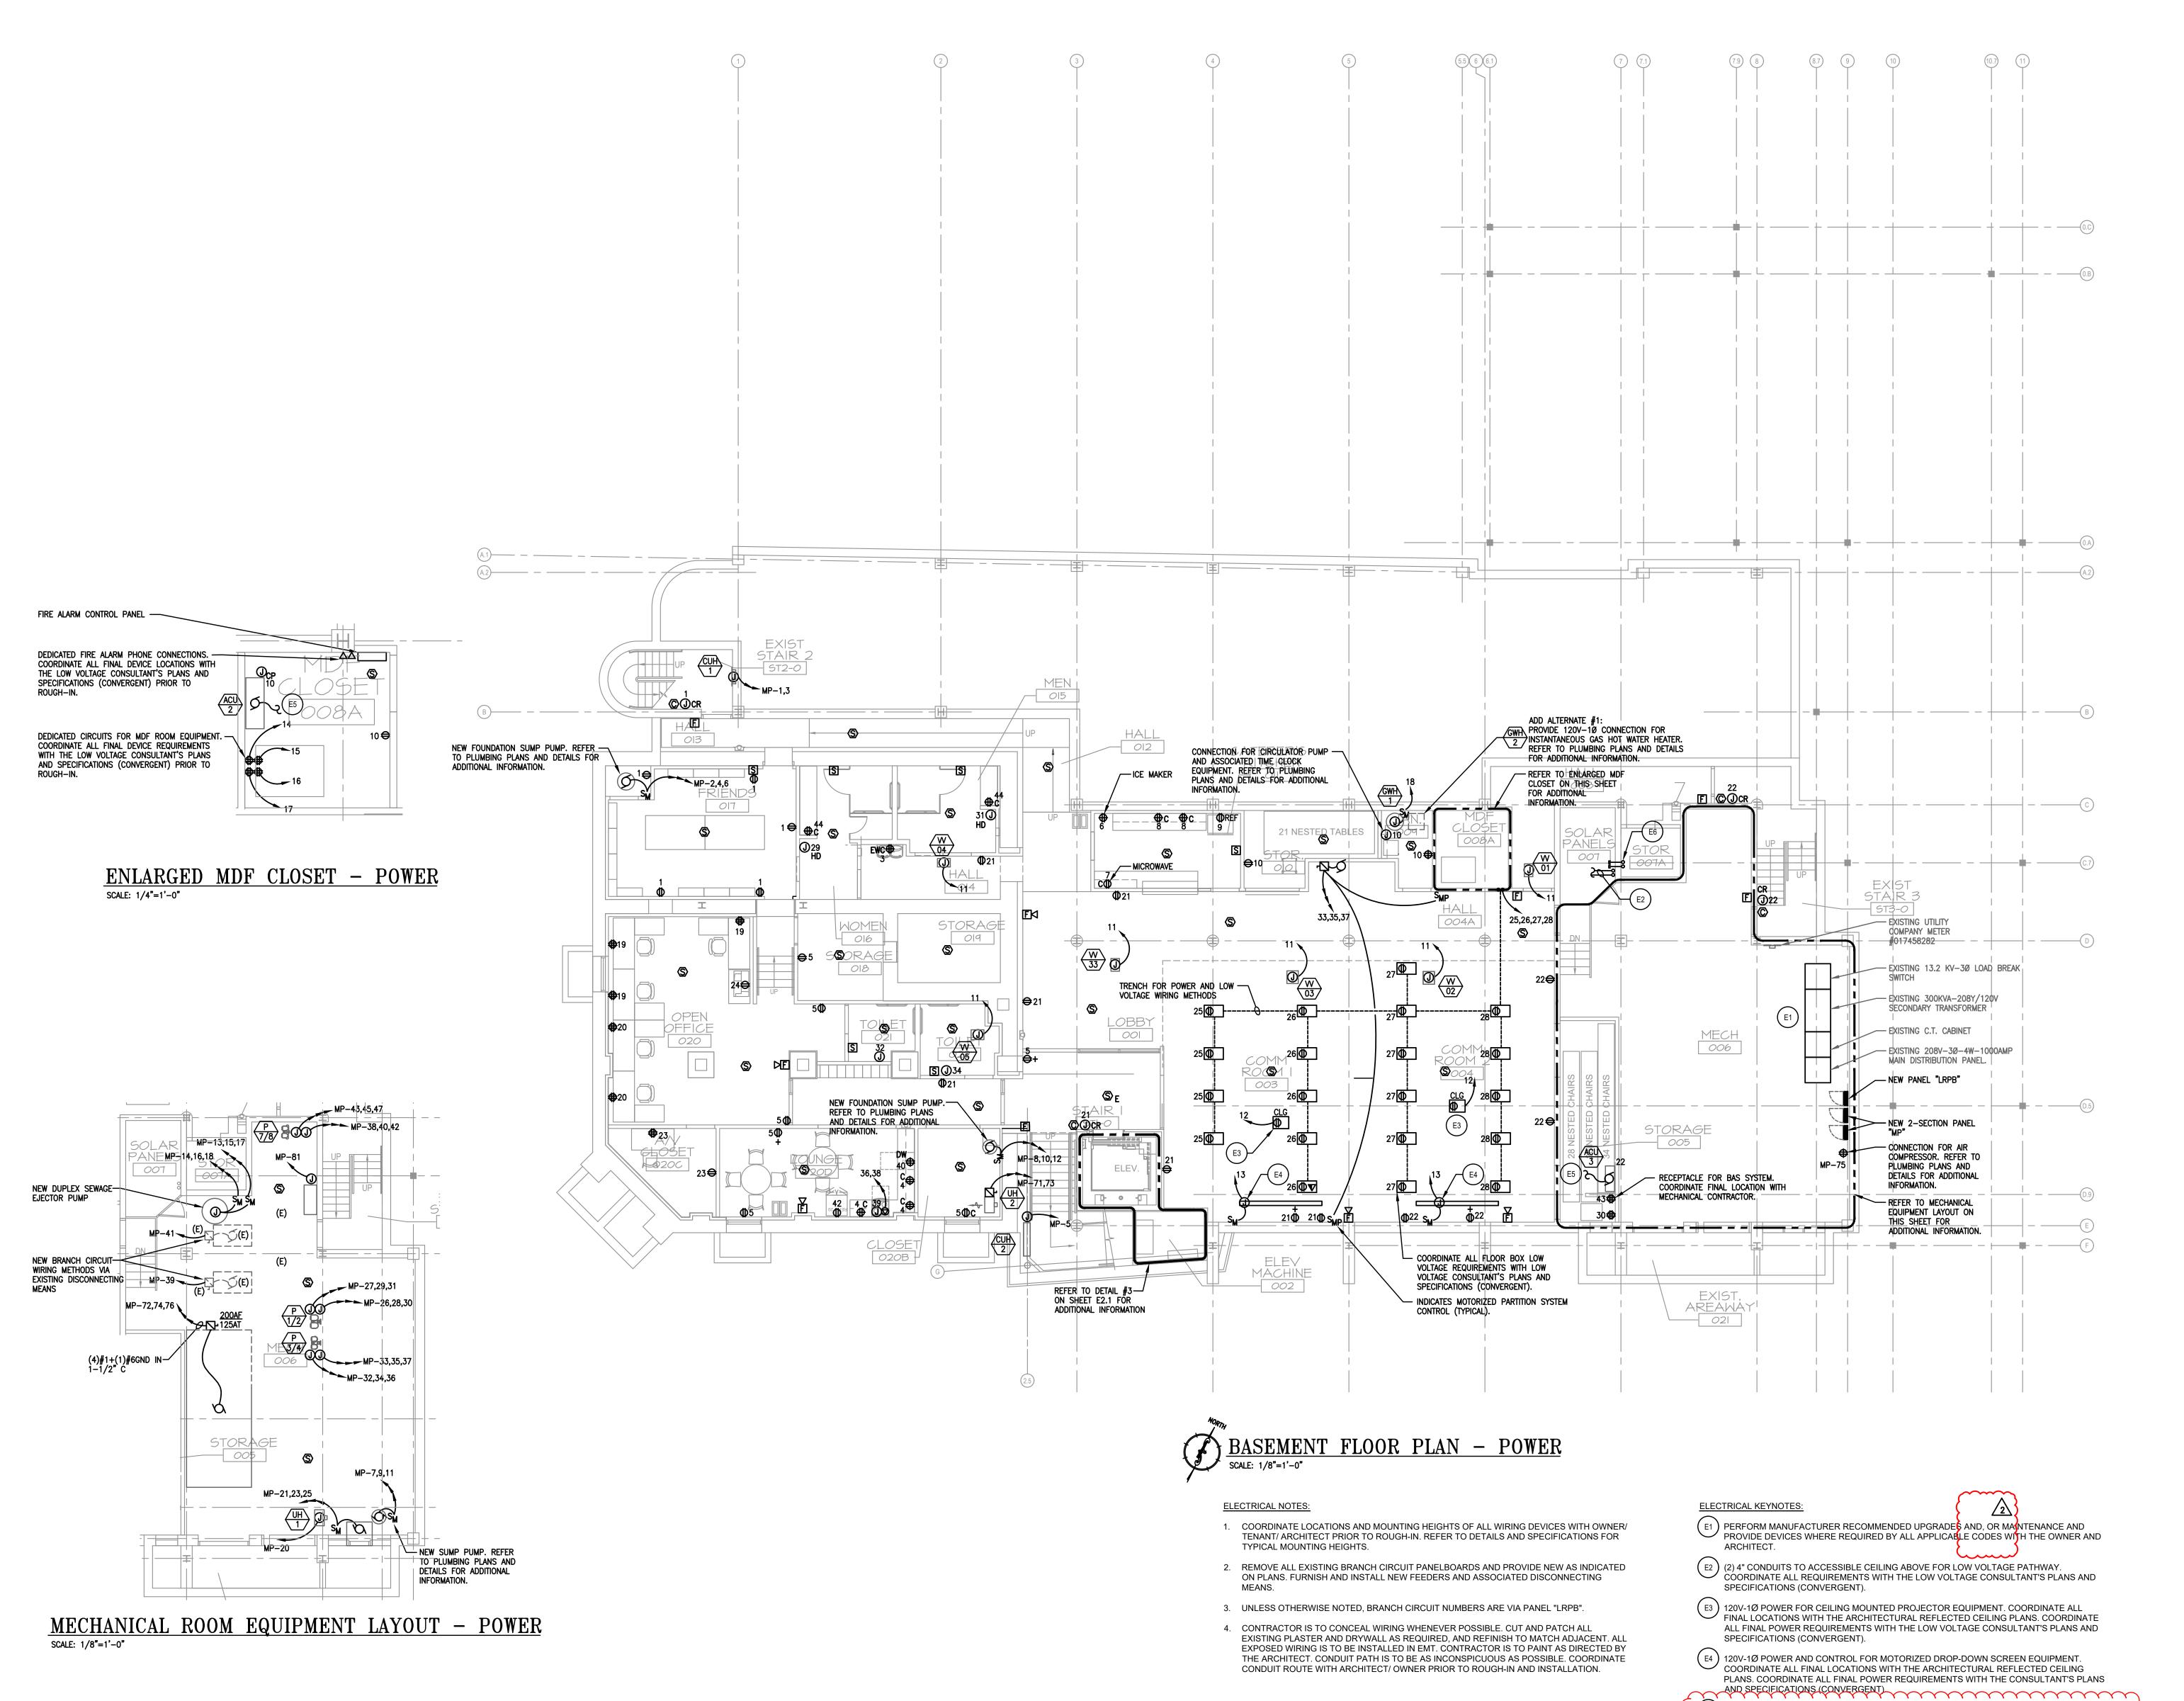

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BASEMENT FLOOR
PLAN - POWER

Sheet Number:

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CONTRACTOR IS BOUND TO PROVIDE. A SUPPLIER OR

POWER FOR ACU IS DERIVED FROM CU LOCATED ON THE ROOF. ALL LOW VOLTAGE WIRING METHODS ARE TO BE PROVIDED BY THE MECHANICAL CONTRACTOR.

(E6) (2) 4" CAPPED CONDUITS WITH PULL-STRINGS UP TO ROOF FOR FUTURE SOLAR PATHWAY.

SECOND FLOOR PLAN - POWER SCALE: 1/8"=1'-0"

- COORDINATE LOCATIONS AND MOUNTING HEIGHTS OF ALL WIRING DEVIC
- 1. COORDINATE LOCATIONS AND MOUNTING HEIGHTS OF ALL WIRING DEVICES WITH OWNER/ TENANT/ ARCHITECT PRIOR TO ROUGH-IN. REFER TO DETAILS AND SPECIFICATIONS FOR
- 2. REMOVE ALL EXISTING BRANCH CIRCUIT PANELBOARDS AND PROVIDE NEW AS INDICATED ON PLANS. FURNISH AND INSTALL NEW FEEDERS AND ASSOCIATED DISCONNECTING MEANS
- 3. UNLESS OTHERWISE NOTED, BRANCH CIRCUIT NUMBERS ARE VIA PANEL "LRP2".
- 4. CONTRACTOR IS TO CONCEAL WIRING WHENEVER POSSIBLE. CUT AND PATCH ALL EXISTING PLASTER AND DRYWALL AS REQUIRED, AND REFINISH TO MATCH ADJACENT. ALL EXPOSED WIRING IS TO BE INSTALLED IN EMT. CONTRACTOR IS TO PAINT AS DIRECTED BY THE ARCHITECT. CONDUIT PATH IS TO BE AS INCONSPICUOUS AS POSSIBLE. COORDINATE CONDUIT ROUTE WITH ARCHITECT/ OWNER PRIOR TO ROUGH-IN AND INSTALLATION.
- 5. UNLESS OTHERWISE NOTED, ALL MOTORIZED SHADE EQUIPMENT AND ASSOCIATED CONTROLS INDICATED ON THIS SHEET ARE TO BE ADD ALTERNATE

ELECTRICAL KEYNOTES:

- PROVIDE TWO-GANG FLOOR BOX POKE THRU DEVICE WITH INSTALLED DUPLEX RECEPTACLE. COORDINATE ALL FINAL LOCATIONS WITH THE ARCHITECT AND OWNER. COORDINATE ALL FINAL LOW VOLTAGE REQUIREMENTS WITH THE LOW VOLTAGE CONSULTANT'S PLANS AND SPECIFICATIONS (CONVERGENT).
- PROVIDE SINGLE-GANG FLOOR BOX POKE THRU DEVICE WITH INSTALLED DUPLEX RECEPTACLE. COORDINATE ALL FINAL LOCATIONS WITH THE ARCHITECT AND OWNER.
- (2) 4" CONDUITS TO ACCESSIBLE CEILING DOWN THE BELOW.
- E4 120V-1Ø POWER AND LOW VOLTAGE FOR CEILING MOUNTED PROJECTOR EQUIPMENT. COORDINATE ALL FINAL LOCATIONS WITH THE ARCHITECTURAL REFLECTED CEILING PLANS. COORDINATE ALL FINAL POWER REQUIREMENTS WITH THE LOW VOLTAGE VENDOR.
- E5 120V-1Ø POWER FOR MOTORIZED DROP-DOWN SCREEN EQUIPMENT. COORDINATE ALL FINAL LOCATIONS WITH THE ARCHITECTURAL REFLECTED CEILING PLANS. COORDINATE ALL FINAL POWER REQUIREMENTS WITH THE LOW VOLTAGE VENDOR.
- (2) 4" CAPPED CONDUITS WITH PULL-STRINGS FROM LOWER LEVEL MECHANICAL ROOM UP TO ROOF FOR FUTURE SOLAR PATHWAY. CONDUIT TO TERMINATE IN RTU ENCLOSURE.
- PROVIDE NEW WALL MOUNTED SYSTEM FURNITURE WHIP DEVICE FOR POWER, AND LOW VOLTAGE WIRING METHODS. COORDINATE ALL FINAL LOW VOLTAGE REQUIREMENTS WITH THE LOW VOLTAGE CONSULTANT'S PLANS AND SPECIFICATIONS (CONVERGENT).
- E8 INDICATES BASE BID MOTORIZED SHADE EQUIPMENT AND ASSOCIATED CONTROLS.

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SECOND FLOOR
PLAN - POWER

Sheet Number:

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ELECTRICAL NOTES:

 COORDINATE LOCATIONS AND MOUNTING HEIGHTS OF ALL WIRING DEVICES WITH OWNER/ TENANT/ ARCHITECT PRIOR TO ROUGH-IN. REFER TO DETAILS AND SPECIFICATIONS FOR TYPICAL MOUNTING HEIGHTS.

ELECTRICAL KEVNOTES:

(2) 4" CAPPED CONDUITS WITH PULL-STRINGS FROM ABANDONED LOWER LEVEL ELEVATOR MACHINE ROOM UP TO ROOF VIA ABANDONED ELEVATOR SHAFT FOR FUTURE SOLAR PATHWAY. CONDUIT IS TO TERMINATE IN RTU ENCLOSURE.

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Sheet Title:
ROOF PLAN

ROOF PLAN -ELECTRICAL

Sheet Number:

E1.6